## Regeneron Pharmaceuticals, Inc.

# Regeneron Guardhouse

81 Columbia Turnpike, Rensselaer, NY 12144



## DRAWING LIST

Sheet Number	Sheet Name
	COVER SHEET
A001	NOTES, LEGENDS & COMcheck
A101	LIFE SAFETY PLAN, FLOOR PLAN, SCHEDULES, DOOR & WINDOW TYPES
A201	<b>BUILDING ELEVATIONS, WINDOW DETAILS</b>
A301	WALL SECTIONS & DETAILS
A302	WALL SECTIONS
A401	ROOF PLAN, CEILING PLAN & DETAILS

## **LOCATION MAP**





22 COMPUTER DRIVE WEST ALBANY, NY 12205 P: (518) 689.2030 F: (518) 689.2088 www.HESNOR.com



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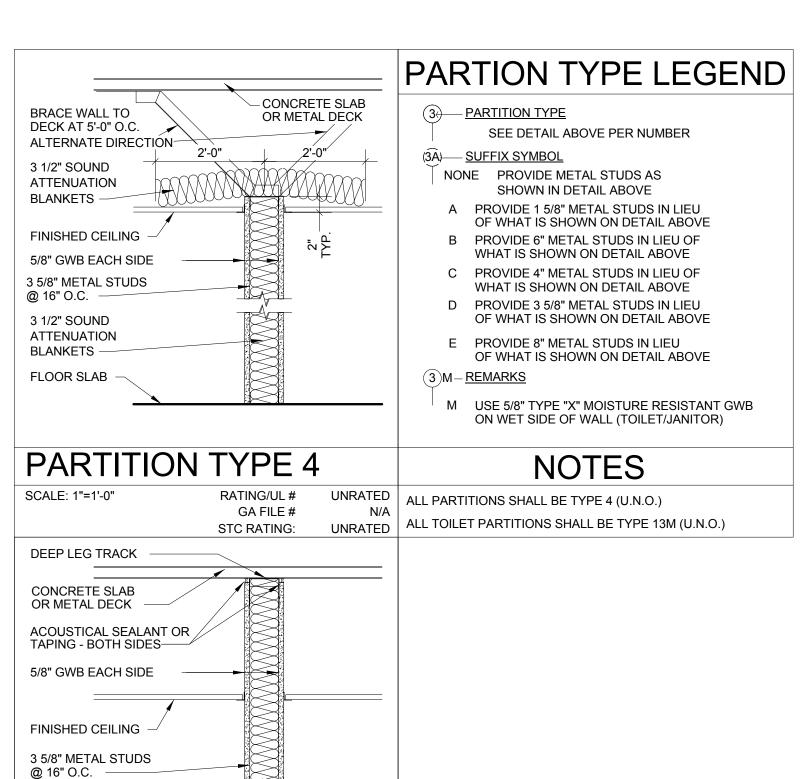
REVISIONS									
No.	No. Description								
<u>/Ô\</u>	PERMIT SET	2/20/2015							

HCP JOB NO.

1444

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SECTION	ITEM	Building Code of NYS 2010	PROJECT DATA		
	OCCUPANCY CLASSIFICATION:				
304.1	Business Occupancy	Group B	Group B		
Table 1004.1.1	Maximum Occupant Load for Business areas:				
	Total First Floor Occupants: 100 sf per occupant / 1,107 sf =		11 Occupants		
	Total sq/ft: 1,107 sf		11 Total Occupants		
able 1005.1 / 1017.2	MEANS OF EGRESS WIDTH  Minimum corridor & door egress widths:				
ibie 1003.1 / 1017.2	First Floor: .15 inches X 11 occupants = 2 inches	doors: 32" / corridors: 44" min.	doors: 35" / corridors: 64" min.		
	First Floor15 linches X 11 occupants – 2 linches	doors, 32 / corridors, 44 mm.	doors: 55 / corridors: 64 mm.		
Table 601	CONSTRUCTION TYPE:	Type IIB	Type IIB		
	AUTOMATIC FIRE PROTECTION SYSTEM:	Type III	Sprinkler system not required		
Table 503	ALLOWABLE BUILDING HEIGHT/STORIES :	(IIB) 55 feet / 4 Stories	13 feet / 1 Story		
504.2	AUTOMATIC SPRINKLER HEIGHT INCREASE:	n/a	n/a		
Table 503	ALLOWABLE BUILDING AREA:	(IIB) 23,000 sf per story	1,107 total sf		
506.3	AUTOMATIC SPRINKLER AREA INCREASE:	n/a	n/a		
	ACTUAL BUILDING AREA:				
506.1.1	First Floor		1,107 sf		
	Total:		1,107 sf		
	FIRE RESISTANCE RATINGS	HOURS	HOURS		
Table 601	Columns, Girders & Trusses:	0	0		
Table 601	Interior Bearing Walls:	0	0		
Table 601	Exterior Bearing Walls:	0	0		
Table 602	Interior & Exterior Non-Bearing Walls:	0	0		
Table 601	Floors & Floor/Ceiling Assemblies: Roofs & Roof/Ceiling Assemblies:	0	0		
Table 601	Fire Separation Distance:	0-30 ft. = 1 hr />30 ft. = 0 hrs	0		
Tuble 001	The Separation Distance.	0-30 It 1 III / 230 It 0 IIIS	0		
	FIRE RESISTANCE SEPARATIONS		1		
707.4, 707.6	Shaft Enclosures:	0 hour	n/a		
707.2(7)	Duct Shaft Enclosures (exception when 2 stories):	not required	n/a		
705.1	Fire Walls:	n/a	n/a		
Table 508.3.3	Separation of Occupancies	n/a (non-separated use)	n/a		
1022	Horizontal Exits	n/a	n/a		
Table 715.4	Opening protective ratings				
	at 2 hour fire barrier	1 1/2 hr (self closing)	1 1/2 hour (self closing)		
	at 1 hour fire barrier (shaft & exit enclosure wall)	1 hour (self closing)	1 hour (self closing)		
	at 1 hour fire barrier (other fire barriers)	3/4 hour (self closing)	3/4 hour (self closing)		
Table 508.2	Incidental Use Areas / Hazardous Area Protection				
	Storage rooms more than 100 sq/ft	*0 hours	0 hours		
	* indicates rating if approved automatic sprinkler system is provided				
	FIRE DAMPERS  Fire dampers not required where a duct connects not more than 2 stories,	-			
16.6.3(2), 707.2(7)	shaft wall is not required to be rated per 707.2(7)		no fire damper provided		
716.5.2	Not required at penetrations of fire barriers with a fire resistance rating of 1	hour or less	n/a		
710.5.2	1 to required at penetrations of the outriers with a fire resistance rating of r	Hour of ress	III II		
	MEANS OF EGRESS				
1008.1.1	Minimum clear opening of exit doors:	32 inches	34 inches		
1019.1	Exits required:	1 exit required < 49 occupants	1 exits provided		
1014.3	Common Path of Egress Travel:	* less than 75 feet	less than 75 feet		
Table 1016.1	Exit Access Travel Distance	*75 feet	51 feet		
1005.1, 1017.2	Minimum corridor width:	44 inches (exceptions)	64 inches		
Table 1017.1	Corridor fire-resistance rating:	*0 hours	0 hours		
1017.3	Maximum dead end:	n/a	n/a		
	* indicates rating or distance if approved automatic sprinkler system is pro	vided			
	Income				
1000 1 1	DOORS	100: 1			
1008.1.1	Minimum door opening clear width:	32 inches	32 inches		
1008.1.1	Maximum door leaf width:	48 inches	48 inches		
1008.1.2	Egress door must swing in the direction of egress serving a space > 50 person Exit access doors cannot obstruct access corridor or stair during their swing		ding and not more than 7" when fully a		
1021.2	LAR access doors cannot obstruct access corridor or stail during their swing	more than 1/2 the width of the corridor of lar	ming and not more than / when fully o		
		1			
1101	DHVSICALI V HANDICADDED ACCESS	Building shall be assessible and assessi-	th ICC/ANSI A1171		
	PHYSICALLY HANDICAPPED ACCESS:	Building shall be accessible and comply wi	un ICC/ANSI ATT/.1		
	ENERGY EFFICIENCY:  See COM-Check form (Designed and constructed in accordance with the En	permy Conservation Construction Code of Nov	y Vork State)		
	ROOF ASSEMBLIES:	Conservation Construction Code of Nev	V TOLK State)		
1507	Minimum roof slope:	1/4" per 12"	1/4" per 12"		
****		z / per z	Person		



3 1/2" SOUND

FLOOR SLAB

SCALE: 1"=1'-0"

ATTENUATION BLANKETS

PARTITION TYPE 13

RATING/UL#

STC RATING:

GA FILE#

WP 1081

ACOUSTICAL SEALANT



#### 2009 IECC

#### Section 1: Project Information

Project Type: New Construction Project Title: Regeneron Guard House

Construction Site: Owner/Agent: Designer/Contractor: 81 Columbia Turnpike Regeneron Pharmaceuticals **BBL Construction Services** Rensselaer, NY 12144

#### Section 2: General Information

Building Location (for weather data): Rensselaer, New York Building Space Conditioning Type(s): Vertical Glazing / Wall Area Pct.: Activity Type(s) Floor Area

#### Section 3: Requirements Checklist

#### Envelope PASSES: Design 3% better than co

#### Climate-Specific Requirements:

Component Name/Description	Gross Area or Perimeter	Cavity R-Value	Cont. R-Value	Proposed U-Factor	Budget U-Factor(a
Roof 1: Insulation Entirely Above Deck	1107		21.0	0.046	0.04
Exterior Wall 1: Steel-Framed, 16" o.c.	1784	6.7	9.8	0.062	0.06
Window 1: Metal Frame with Thermal Break, Perf. Type: Other testing/cert. Product ID: , SHGC 0.47 (c)	144			0.480	0.55
Window 2: Metal Frame with Thermal Break, Perf. Type: Other testing/cert. Product ID: , SHGC 0.61 (c)	24			0.828	0.55
Door 1: Insulated Metal, Swinging	24			0.130	0.70
Floor 1: Slab-On-Grade:Unheated, Vertical 4 ft.	145		9.8		-

(a) Budget U-factors are used for software baseline calculations ONLY, and are not code requirements. (b) 'Other' components require supporting documentation for proposed U-factors.

(c) Fenestrations product performance must be certfied in accordance with NFRC and requires supporting documentation.

#### Air Leakage, Component Certification, and Vapor Retarder Requirements:

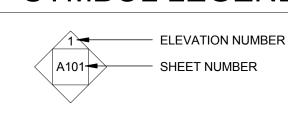
- 1. All joints and penetrations are caulked, gasketed or covered with a moisture vapor-permeable wrapping material installed in accordance with the manufacturer's installation instructions.
- ☐ 2. Windows, doors, and skylights certified as meeting leakage requirements.
- 3. Component R-values & U-factors labeled as certified. ☐ 4. No roof insulation is installed on a suspended ceiling with removable ceiling panels.
- 5. 'Other' components have supporting documentation for proposed U-Factors.
- a 6. Insulation installed according to manufacturer's instructions, in substantial contact with the surface being insulated, and in a manner that achieves the rated R-value without compressing the insulation.
- \_\_\_\_ 7. Stair, elevator shaft vents, and other outdoor air intake and exhaust openings in the building envelope are equipped with motorized
- 8. Cargo doors and loading dock doors are weather sealed. 9. Recessed lighting fixtures installed in the building envelope are Type IC rated as meeting ASTM E283, are sealed with gasket or caulk.
- ☐ 10.Building entrance doors have a vestibule equipped with self-closing devices.
- ☐ Building entrances with revolving doors.
- □ Doors not intended to be used as a building entrance.
- □ Doors that open directly from a space less than 3000 sq. ft. in area.
- Doors used primarily to facilitate vehicular movement or materials handling and adjacent personnel doors. ☐ Doors opening directly from a sleeping/dwelling unit.

#### Section 4: Compliance Statement

Compliance Statement: The proposed envelope design represented in this document is consistent with the building plans, specifications and other calculations submitted with this permit application. The proposed envelope system has been designed to meet the 2009 IECC requirements in COMcheck Version 3.9.4 and to comply with the mandatory requirements in the Requirements Checklist.

Name - Title

#### SYMBOL LEGEND



SECTION NUMBER 、A101<del>≠</del>-SHEET NUMBER

- DETAIL NUMBER - SHEET NUMBER 、A101 <del>∕−</del>−

PARTITION / WALL / **CURTAIN WALL TYPES** 


VINYL BUMPER RAIL

C.G. CORNER GUARD -VINYL OR WOOD -SEE FINISH DRAWINGS

FIRE EXTINGUISHER CABINET (101) DOOR NUMBER

> ROOM **→** ROOM NAME A101 ← ROOM NUMBER


### MATERIAL LEGEND

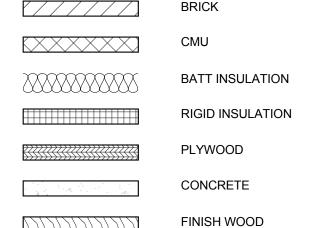

WOOD BLOCKING STEEL

GYPSUM WALL BOARD

## **DIMENSION KEY**

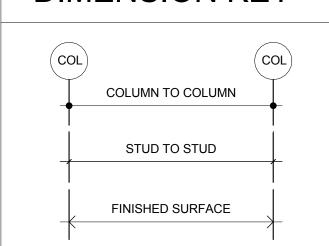

#### **GENERAL NOTES**

- 1 ALL NOTES HEREIN MENTIONED AND WITH THOSE ON THE VARIOUS DRAWINGS SHALL APPLY TO ALL DRAWINGS AND FORM PART OF THE CONTRACT.
- 2 ALL WORK SHALL CONFORM TO ALL APPLICABLE FEDERAL, STATE AND LOCAL CODES AND ORDINANCES HAVING JURISDICTION.

ARCHITECT PRIOR TO BEING EXECUTED BY ANY SUB-CONTRACTOR, VENDOR OR SUPPLIER.

- 3 ANY AND ALL DEVIATION FROM THE CONTRACT DOCUMENTS SHALL REQUIRE WRITTEN APPROVAL FROM THE
- 4 ALL EXISTING DIMENSIONS AND CONDITIONS SHALL BE CHECKED AND VERIFIED. ANY DISCREPANCIES BETWEEN EXISTING CONDITIONS AND CONSTRUCTION DOCUMENT DRAWINGS SHALL BE BROUGHT TO THE ATTENTION OF THE ARCHITECT FOR CLARIFICATION PRIOR TO COMMENCING THE WORK. NO

COMPENSATION WILL BE PAID TO ANY CONTRACTOR FOR WORK HAVING TO BE REDONE DUE TO SUCH

5 ALL DIMENSIONS OF MASONRY UNITS ARE NOMINAL.

DISCREPANCIES IF REQUIRED NOTIFICATION HAS NOT BEEN GIVEN.

- 6 ALL DIMENSIONS ARE FROM FACE OF STUD, UNLESS NOTED OTHERWISE. ALL INTERIOR ELEVATIONS AND LARGE PLAN DIMENSIONS ARE FROM FINISHED SURFACES. CALCULATED DIMENSIONS AND LARGE SCALE DETAILS TAKE PRECEDENCE OVER SCALED DIMENSIONS AND SMALL SCALE DETAILS. REPETITIVE FEATURES NOT COMPLETELY DESCRIBED AND/OR DETAILED SHALL BE CONSTRUCTED IN EXACT ACCORDANCE WITH CORRESPONDING FEATURES THAT ARE COMPLETELY DESCRIBED OR DETAILED.
- 7 DO NOT CUT AND/OR PATCH STRUCTURAL WORK IN SUCH A MANNER RESULTING IN A REDUCTION IN LOAD CARRYING CAPACITY. PRIOR APPROVAL FROM ENGINEER AND/OR ARCHITECT IS REQUIRED.
- 8 ALL CONCRETE BLOCK COURSES SHALL START FROM FINISH FLOOR UNLESS OTHERWISE NOTED.
- 9 SEE MECHANICAL AND STRUCTURAL DRAWINGS FOR SIZES AND LOCATIONS OF PITS, EQUIPMENT, TANKS,
- 10 CONTRACTORS SHALL MAINTAIN PROPER RATINGS WHEN PENETRATING WALLS, FLOORS AND/OR CEILINGS IN ALL CIRCUMSTANCES.
- 11 COMPLY WITH MANUFACTURER'S INSTALLATION INSTRUCTIONS AND RECOMMENDATIONS TO THE EXTENT THAT THEY ARE MORE STRINGENT THAN REQUIREMENTS IN THE CONTRACT DOCUMENTS.
- 12 INSTALL COMPONENTS AT STANDARD MOUNTING HEIGHTS. REFER QUESTIONS TO THE ARCHITECT WHERE MOUNTING HEIGHTS ARE NOT INDICATED.
- 13 METHOD AND TYPE OF CONSTRUCTION, MATERIALS AND/OR EQUIPMENT SHALL CONFORM TO THE REQUIREMENTS OF ALL GOVERNING AUTHORITIES.
- COORDINATION BY APPLICABLE TRADES IS REQUIRED. 15 ARCHITECTURAL DRAWINGS INDICATE ELECTRICAL OUTLETS AND PLUMBING FOR CLARITY AND REFERENCE

14 EQUIPMENT MANUFACTURER'S REQUIREMENTS MAY CHANGE WITH CURRENT UPDATES OR SUBSTITUTIONS.

- ONLY. APPLICABLE TRADES SHALL REFER TO MECHANICAL AND ELECTRICAL DRAWINGS FOR
- 16 GYPSUM WALL BOARD IN ALL WET AREAS, I.E., TOILET ROOMS, SHOWER ROOMS, TUB ROOMS, SOILED UTILITY ROOMS, JANITOR CLOSETS, KITCHENS, ETC., SHALL BE WATER/MOISTURE RESISTANT. SUBSTITUTE CEMENTITIOUS BACKER BOARD AT ALL AREAS HAVING CERAMIC TILE WALL FINISH.
- 17 CONTRACTOR SHALL PROVIDE TYPE 'X' GYPSUM WALL BOARD WHERE FIRE RATED PARTITIONS ARE
- 18 CONTRACTOR SHALL INSTALL ALL CEILING AND WALL ACCESS DOORS SUPPLIED BY OTHER TRADES. SEE MECHANICAL, ELECTRICAL AND/OR PLUMBING DRAWINGS FOR NUMBER AND LOCATION.
- 19 CONTRACTOR SHALL FURNISH AND INSTALL ANGLES, STRUTS, BRACKETS, TOGGLES, EYE BOLTS AND ALL ACCESSORIES REQUIRED TO PROPERLY SUPPORT BRACE AND/OR REINFORCE ALL FINISHED FRAMES AND/OR EQUIPMENT, ETC.

20 CONTRACTOR SHALL CLOSE ALL OPENINGS CREATED BY MECHANICAL AND ELECTRICAL CONTRACTORS.

- OPENINGS SHALL BE CLOSED AND FINISHED TO MATCH EXISTING. SEE MECHANICAL AND ELECTRICAL DRAWINGS FOR MORE INFORMATION.
- 21 'TYPICAL' INDICATES THE EXTENT OF WORK TO BE EXECUTED AS THE SAME USE, LAYOUT, CONSTRUCTION
- 22 SEE STRUCTURAL DRAWINGS FOR ALL CONCRETE AND STEEL DIMENSIONS.
- 23 REFER TO PLUMBING DRAWINGS FOR LOCATIONS OF NEW FLOOR AND SHOWER DRAINS.
- 24 ALL NEW PIPING AND ELECTRIC CONDUITS SHALL BE CONCEALED WITHIN NEW PARTITIONS.
- 25 ALL EXTERIOR METAL STAIRS, LADDERS, GRATINGS, LINTELS, ETC., EXPOSED TO THE WEATHER SHALL BE GALVANIZED.
- 26 CONTRACTOR SHALL PROVIDE LOOSE LINTELS OVER ALL PENETRATIONS AND MISCELLANEOUS OPENINGS THROUGH MASONRY PARTITIONS FOR DUCTS, FIRE EXTINGUISHER CABINETS, FIRE HOSE CABINETS, ETC. SEE MECHANICAL. ELECTRICAL AND PLUMBING DRAWINGS FOR LOCATIONS. SEE STRUCTURAL NOTES FOR MORE INFORMATION.
- 27 REQUIRED CONCRETE BASES FOR MECHANICAL AND ELECTRICAL EQUIPMENT SHALL BE FURNISHED AND COORDINATED BY CONTRACTOR. DIMENSION, STRENGTH AND LOCATION REQUIREMENTS SHALL BE OBTAINED FROM THE MANUFACTURER, ARCHITECT, MECHANICAL, ELECTRICAL AND/OR STRUCTURAL ENGINEER. SHOP DRAWINGS APPROVED BY THE ARCHITECT ARE REQUIRED PRIOR TO COMMENCING THE

### **ABBREVIATIONS**

BEARING

BRICK SHELF

CONTROL JOINT

COMPOSITION FLOORING

CONCRETE MASONRY UNIT

BRICK

CEILING

COLUMN

CONCRETE

CONNECTING

CONTINUOUS

COORDINATE

CERAMIC TILE

**DRINKING FOUNTAIN** 

FIRE EXTINGUISHER CABINET

EXPANSION JOINT

CORRIDOR

**ELEVATION** 

**ELEVATION** 

EDGE OF SLAB

**EPOXY PAINT** 

**EXPANSION** 

**FIBERGLASS** 

**FOUNDATION** 

FACE OF BRICK

GYPSUM WALLBOARD

LIQUID SOAP DISPENSER

MASONRY OPENING

NOT IN CONTRACT

PRESSURE TREATED

PAINT - SEMI-GLOSS

PAPER TOWEL DISPENSER

PORCELAIN TILE

**QUARRY TILE** 

ROOF DRAIN

SIMILAR

STEEL

TOP OF

**TYPICAL** 

VINYL

**ROUGH OPENING** 

SATIN CLEAR FINISH

STAINLESS STEEL

STRUCTURAL

SHEET VINYL

**VAPOR BARRIER** 

SECONDARY ROOF DRAIN

STANDARD WIRE GAUGE

**UNLESS NOTED OTHERWISE** 

VINYL COMPOSITION TILE

VINYL WALL COVERING

WASTE RECEPTACLE

WOOD VENEER WALL COVERING

**ROOF TOP UNIT** 

**EQUAL** 

GAUGE

HOUR

JOINT

GRAB BAR

**HIGH POINT** 

INSULATION

LAMINATE

POUND

MARBLE

METAL

**NOMINAL** 

ON CENTER

**OVERHANG** 

OPPOSITE

PLATE

PAINT

PLASTIC

AFF

**ALUM** 

B.O.

BRK

CF

CJ

**CLNG** 

CMU

COL

CONC

CONN

CONT

COORD

CORR

CT

ELEV

EOS

EP

EQ

EXP

FEC

FOB

GΑ

GB

**INSUL** 

ΙB

LSD

MAR

MTL

NOM

OC

OH

P.T.

**PLAS** 

PSG

PT

PTD

QT

SCF

SIM

SS

STL

STRUCT

T.O.

VIN

ACOUSTIC CEILING PANEL ABOVE FINISHED FLOOR ALUMINUM **BOTTOM OF** BARRIER

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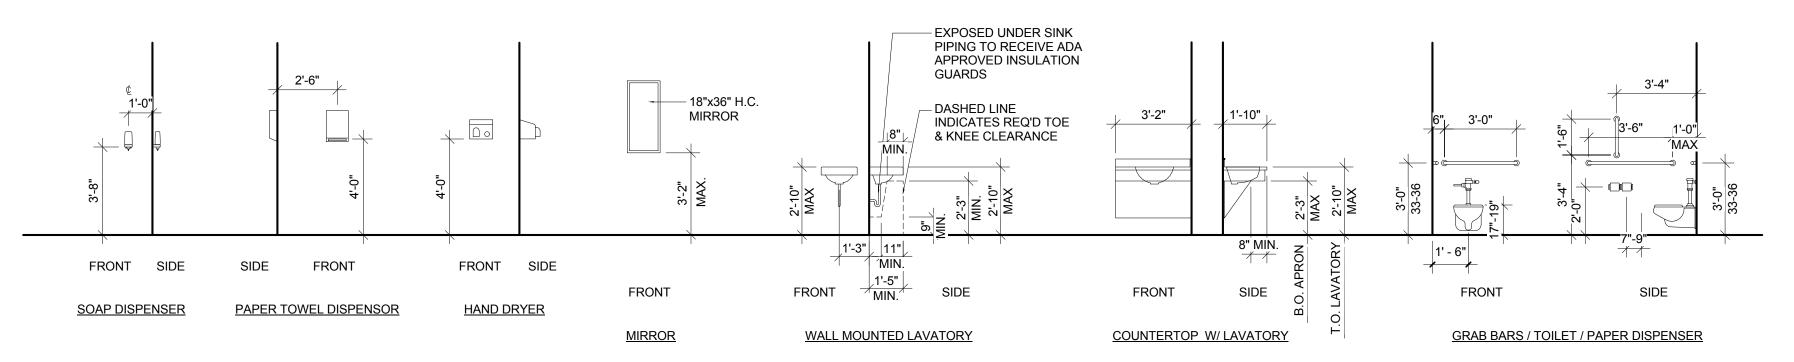
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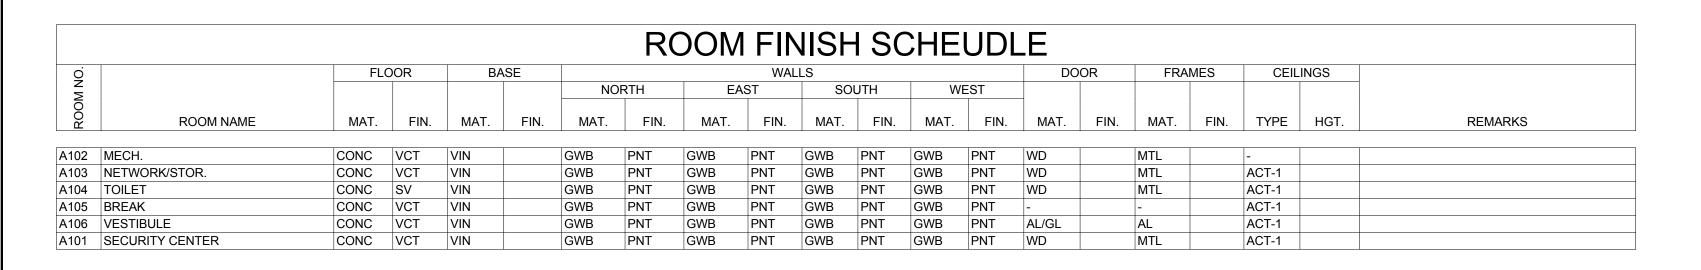
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DRAWING TITLE: NOTES, LEGENDS & COMcheck


DRAWING NUMBER:



**ACCESSIBLE MOUNTING HGT** 



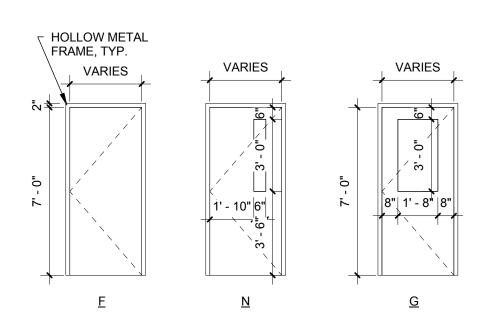						OOOR	SCH	EDI	JLE							
	DOORS	S									FRAME					
DOOR	TO		FROM		SIZE							JAMB	HEAD	FIRE	HARDWARE	
NUMBER	NO.	NAME	NO.	NAME	WIDTH	HEIGHT	THICK.	TYPE	MAT.	LOUVER	MAT.	DETAIL	DETAIL	RATING	GROUP	COMMENTS
								·								
A101	A105	BREAK	A106	VESTIBULE	3' - 0"	7' - 0"	0' - 1 3/4"	N	WD						1	
A102	A106	VESTIBULE	A102	MECH.	2' - 6"	7' - 0"	0' - 1 3/4"	F	WD						5	
A103	A103	NETWORK/STOR.	A106	VESTIBULE	3' - 0"	7' - 0"	0' - 1 3/4"	F	WD						5	CARD READER
A104	A104	TOILET	A106	VESTIBULE	3' - 0"	7' - 0"	0' - 1 3/4"	F	WD						2	
A106	A106	VESTIBULE			3' - 0"	7' - 0"	0' - 1 3/4"	G	HM		HM	1/A901	1/A901	-	13AW	CARD READER, PANIC




DOOR	TYPES
1/4" = 1'-0"	

Н	ARDWA	ARE G	ROUP	LEGE	END		
LOCKSET T	YPES —	(EX	1 A ◀	SU	FFIX SYMBOL		
LOCKSET#	LOCKSET # DESCR		SUFFIX	SYMBOL	DESCRIPTION		
1	PASSA	.GE	A		PASSAGE		
2	PRIVACY		W		WEATHERSTRIPPING, SWEEP, SADDLE FIRE LABELED DEVICE		
5	STORER	ООМ	M F				
7	OFFIC	Œ					
8	CLASSR	ООМ	DOOR SCHEDULE				
9	PANI	С	]   <b>F</b>	REMARK ABBREVIATIONS			
10	PUSH/P	ULL	AUTO KP		TOMATIC DOOR OPENER		
11	DUMMY <sup>-</sup>	DUMMY TRIM		MO	TION DETECTION DEVICE		
12	SLIDE	RS	NRP PD		NON REMOVABLE PIN HINGES PADDLE DEVICE		
13 CYLINDERS		ES MH		ELECTRIC STRIKE MAGNETIC HOLD-OPEN			

## LIFE SAFETY LEGEND



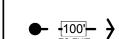EXIT EGRESS DOOR



DIAGONAL DISTANCE FOR EGRESS

EGRESS TRAVEL DISTANCE



CEILING MOUNTED EXIT LIGHT FIXTURE

FIRE EXTINGUISHER CABINET

EXIT EMERGENCY LIGHT FIXTURE, SEE ELEC. DRAWINGS

#### **PLAN NOTES**

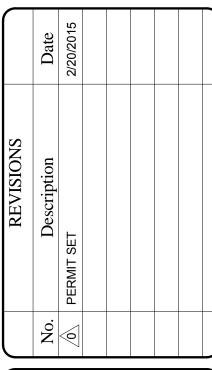
- 1 ALL DIMENSIONS ARE FROM FACE OF STUD, UNLESS NOTED OTHERWISE. ALL INTERIOR ELEVATIONS AND LARGE PLAN DIMENSIONS ARE FROM FINISHED SURFACES.
- 2 ALL PARTITIONS ARE 3 5/8", UNLESS NOTED OTHERWISE.
- HARDWARE GROUPS ARE TO BE DESIGNATED ON SEPARATE SCHEDULE.
- 4 FURNITURE IS NOT IN CONTRACT (N.I.C.) AND SHOWN FOR REFERENCE ONLY.
- 5 ALL EXPOSED PLUMBING UNDER THE SINKS IS TO BE COVERED AS REQUIRED BY ADA.
- 6 ALL PLASTIC LAMINATE SHELVING TO BE 3/4" THICK MEDIUM DENSITY PARTICLE BOARD, UNLESS NOTED OTHERWISE.

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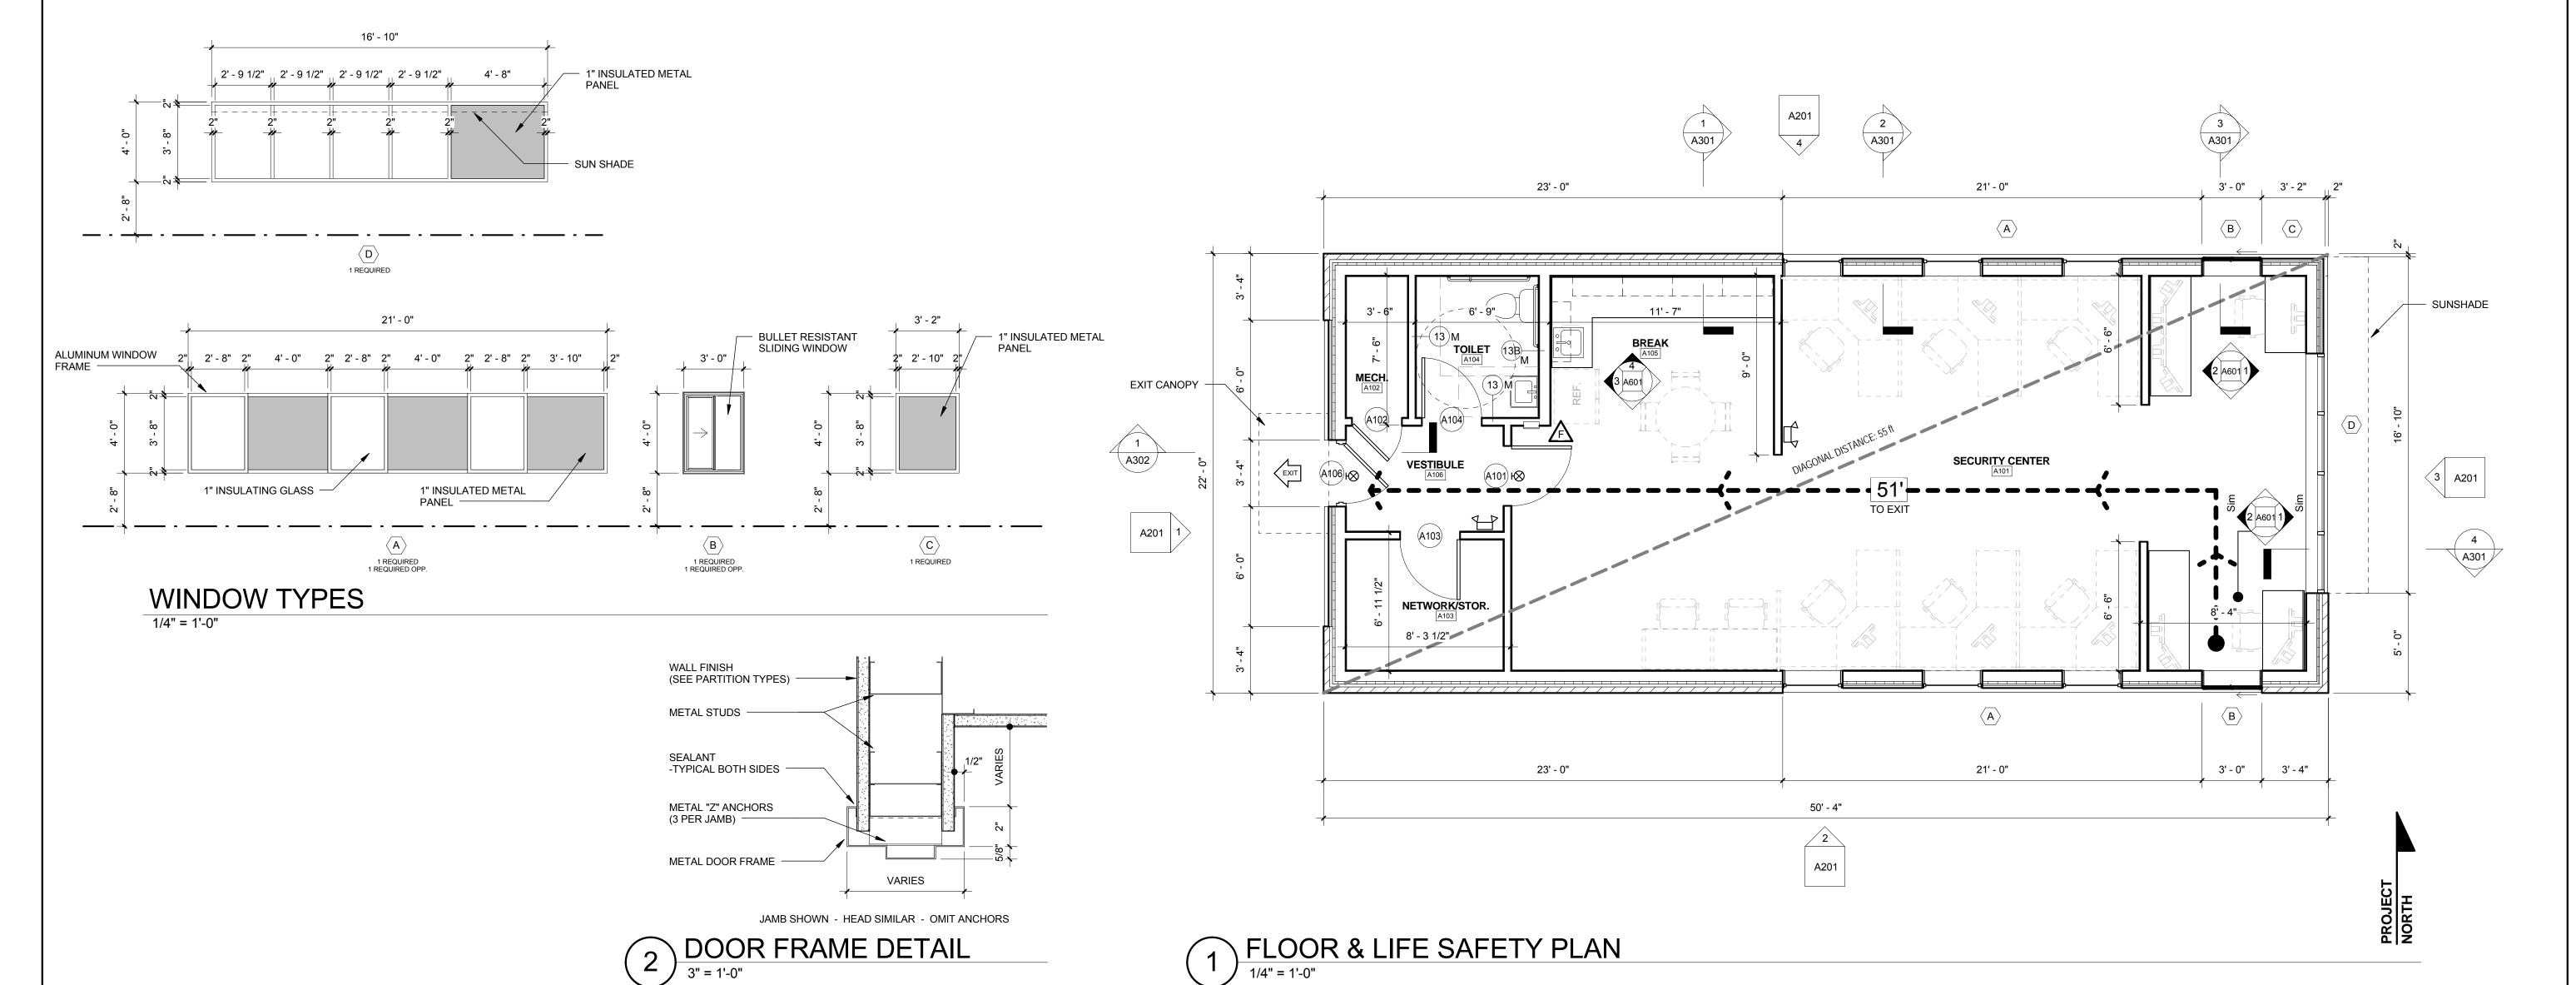
Regeneron Regeneron




HCP JOB NO.: 1444

DRAWING TITLE: LIFE SAFETY PLAN, FLOOR PLAN, SCHEDULES, DOOR & WINDOW TYPES

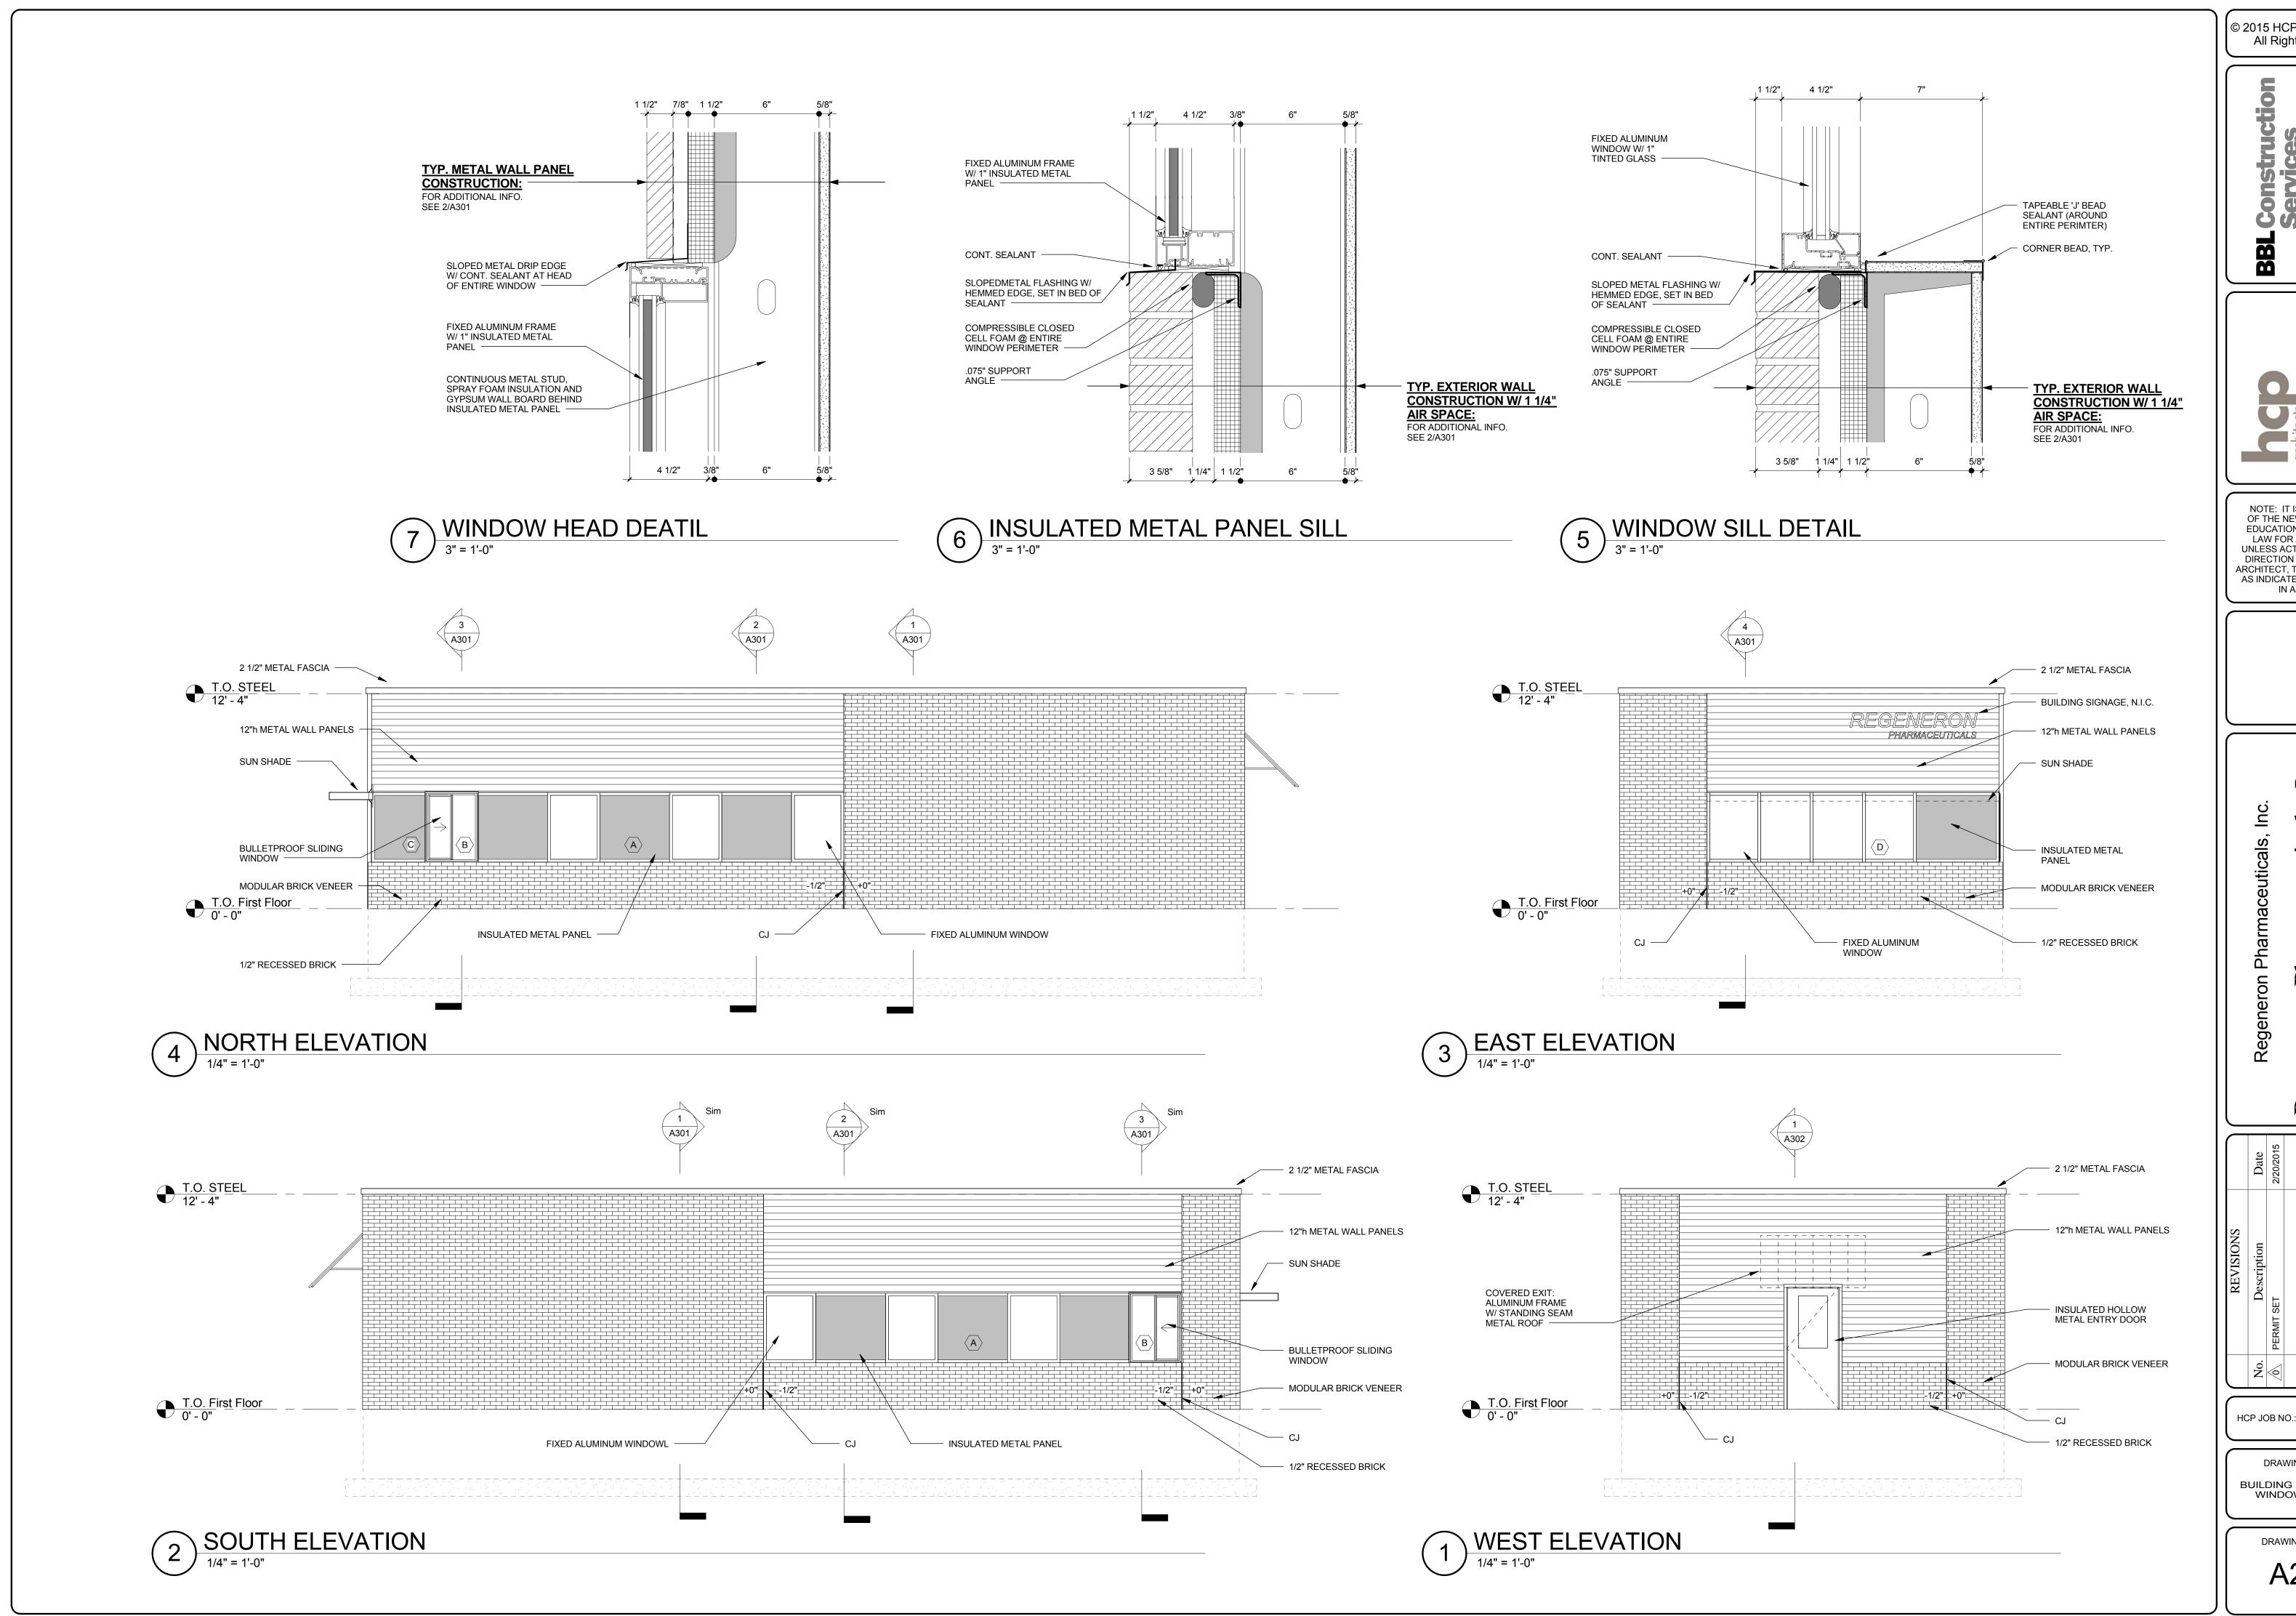DRAWING NUMBER: A101





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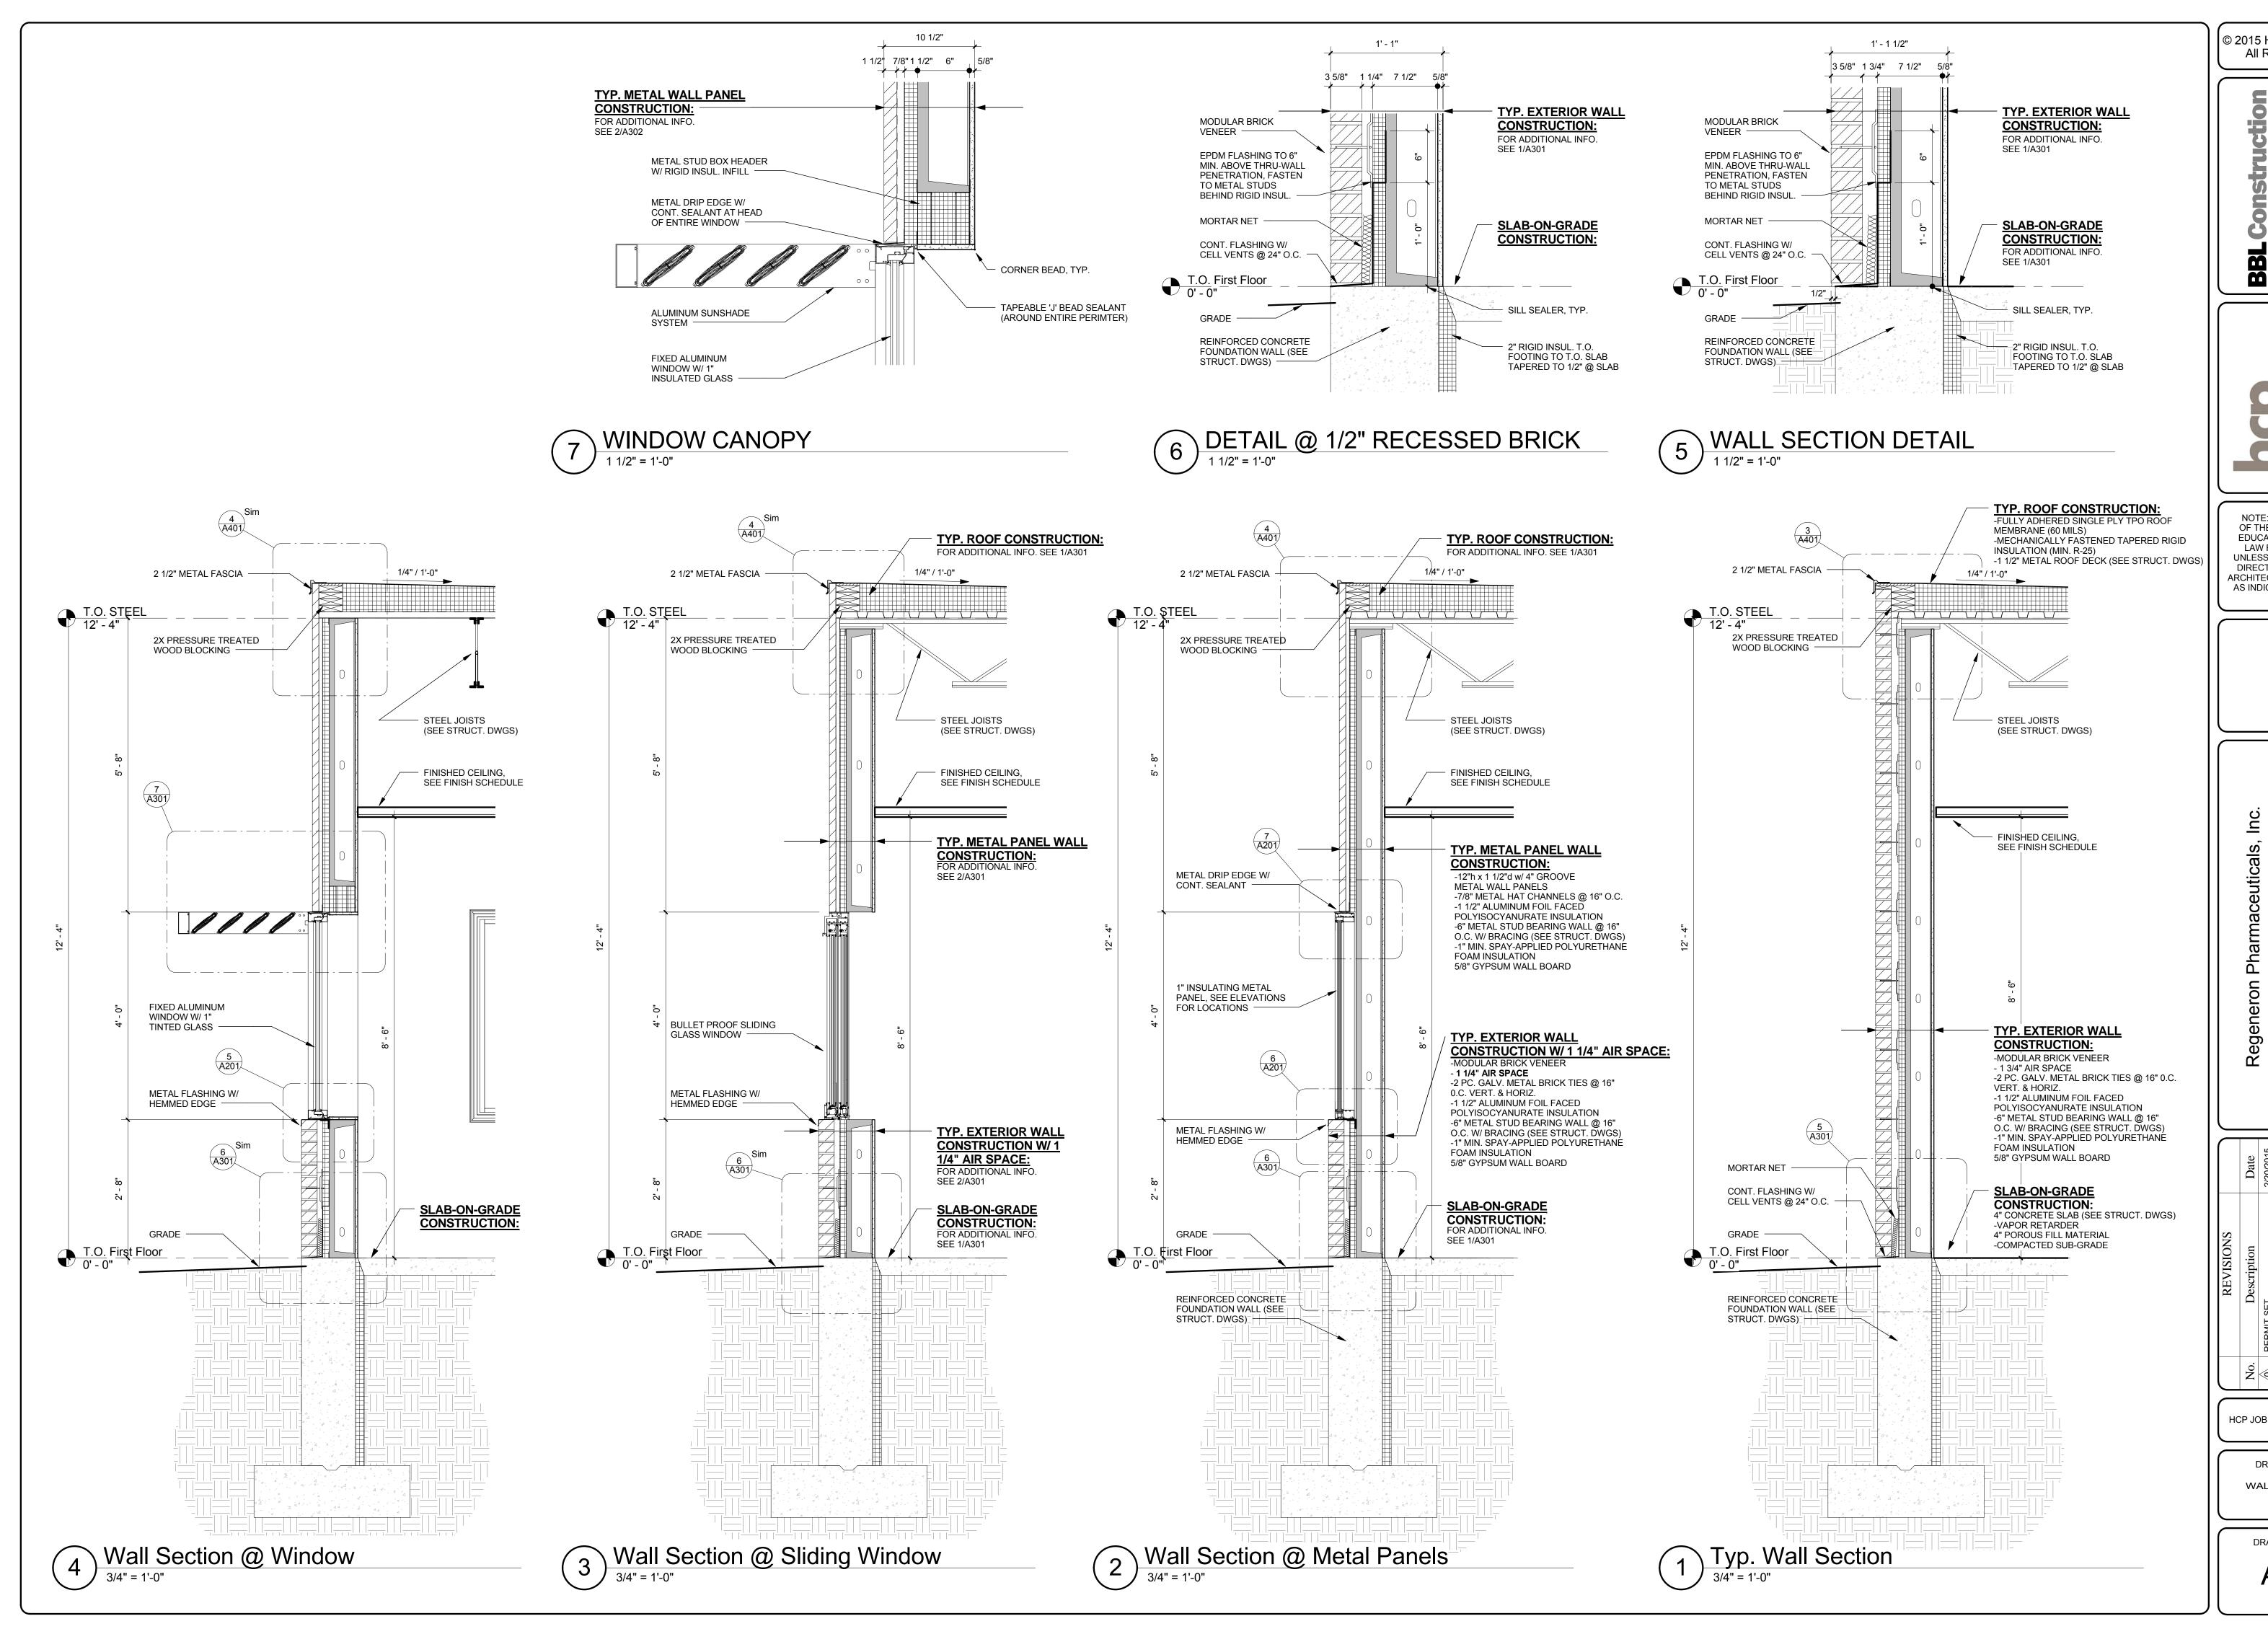
Regeneron

HCP JOB NO.: 1444

DRAWING TITLE: BUILDING ELEVATIONS, WINDOW DETAILS

DRAWING NUMBER:

A201



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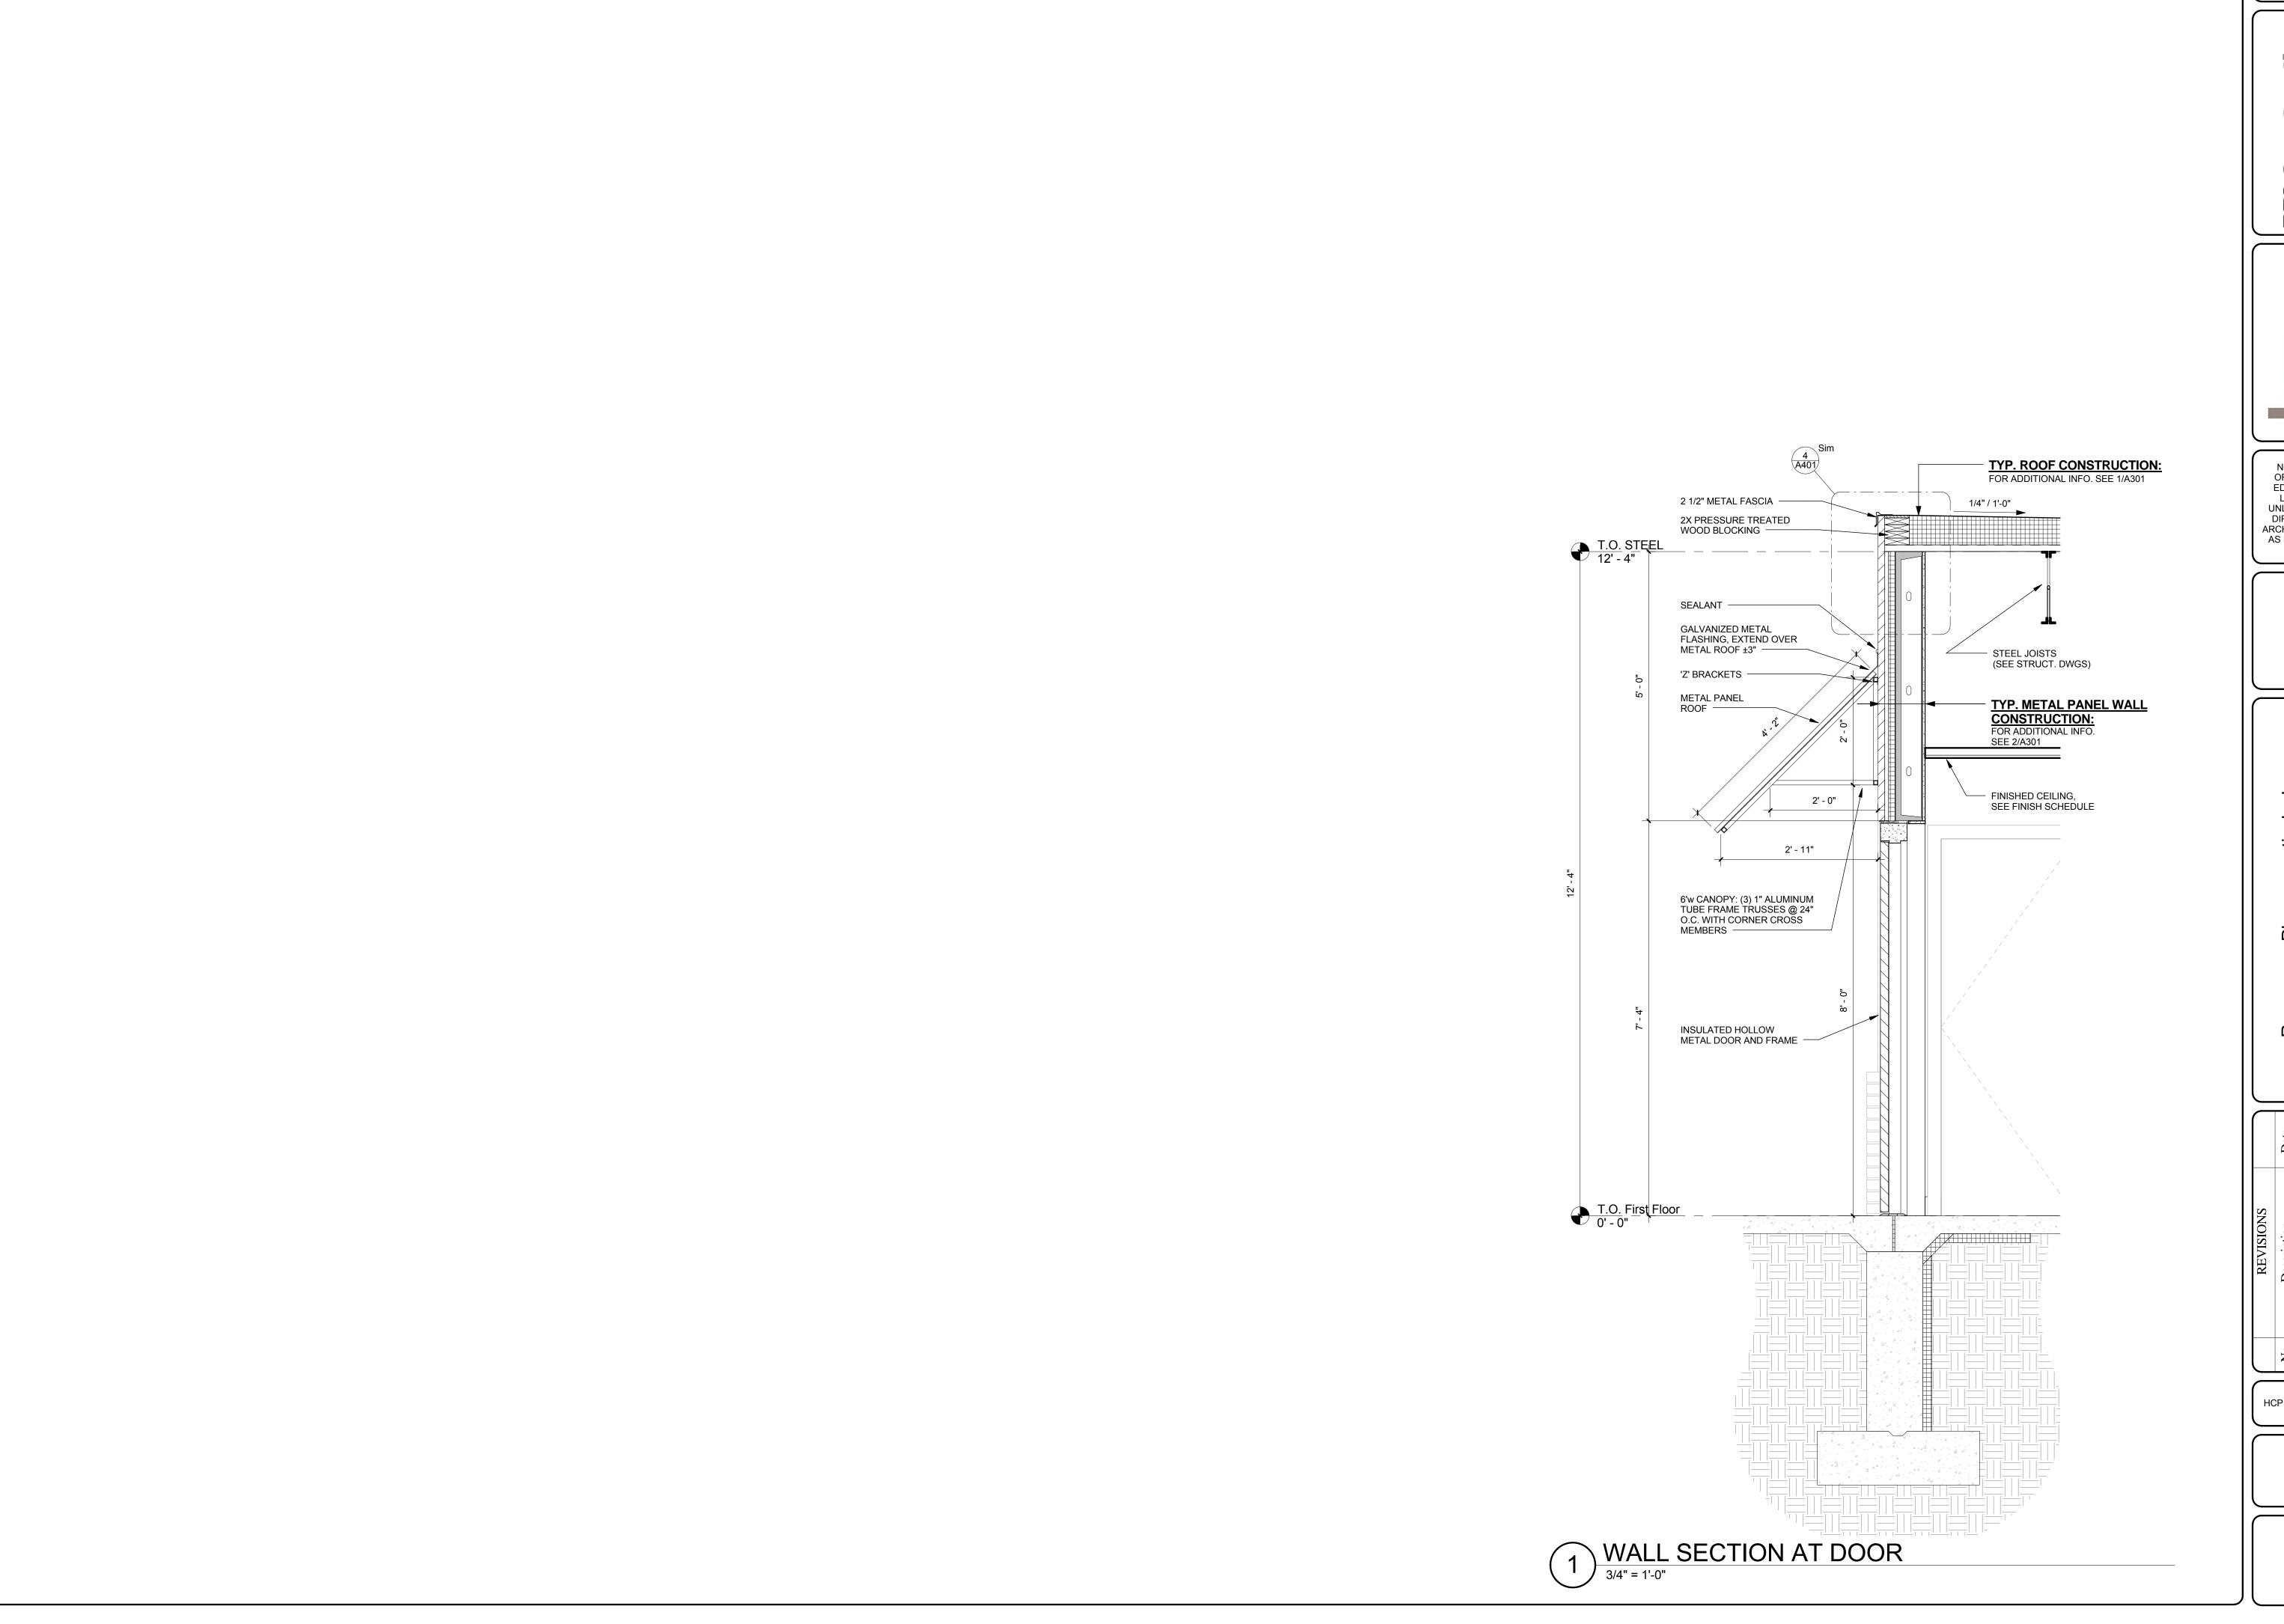
No. Description Date

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нср јов no.: 1444

DRAWING TITLE:
WALL SECTIONS &
DETAILS

DRAWING NUMBER:



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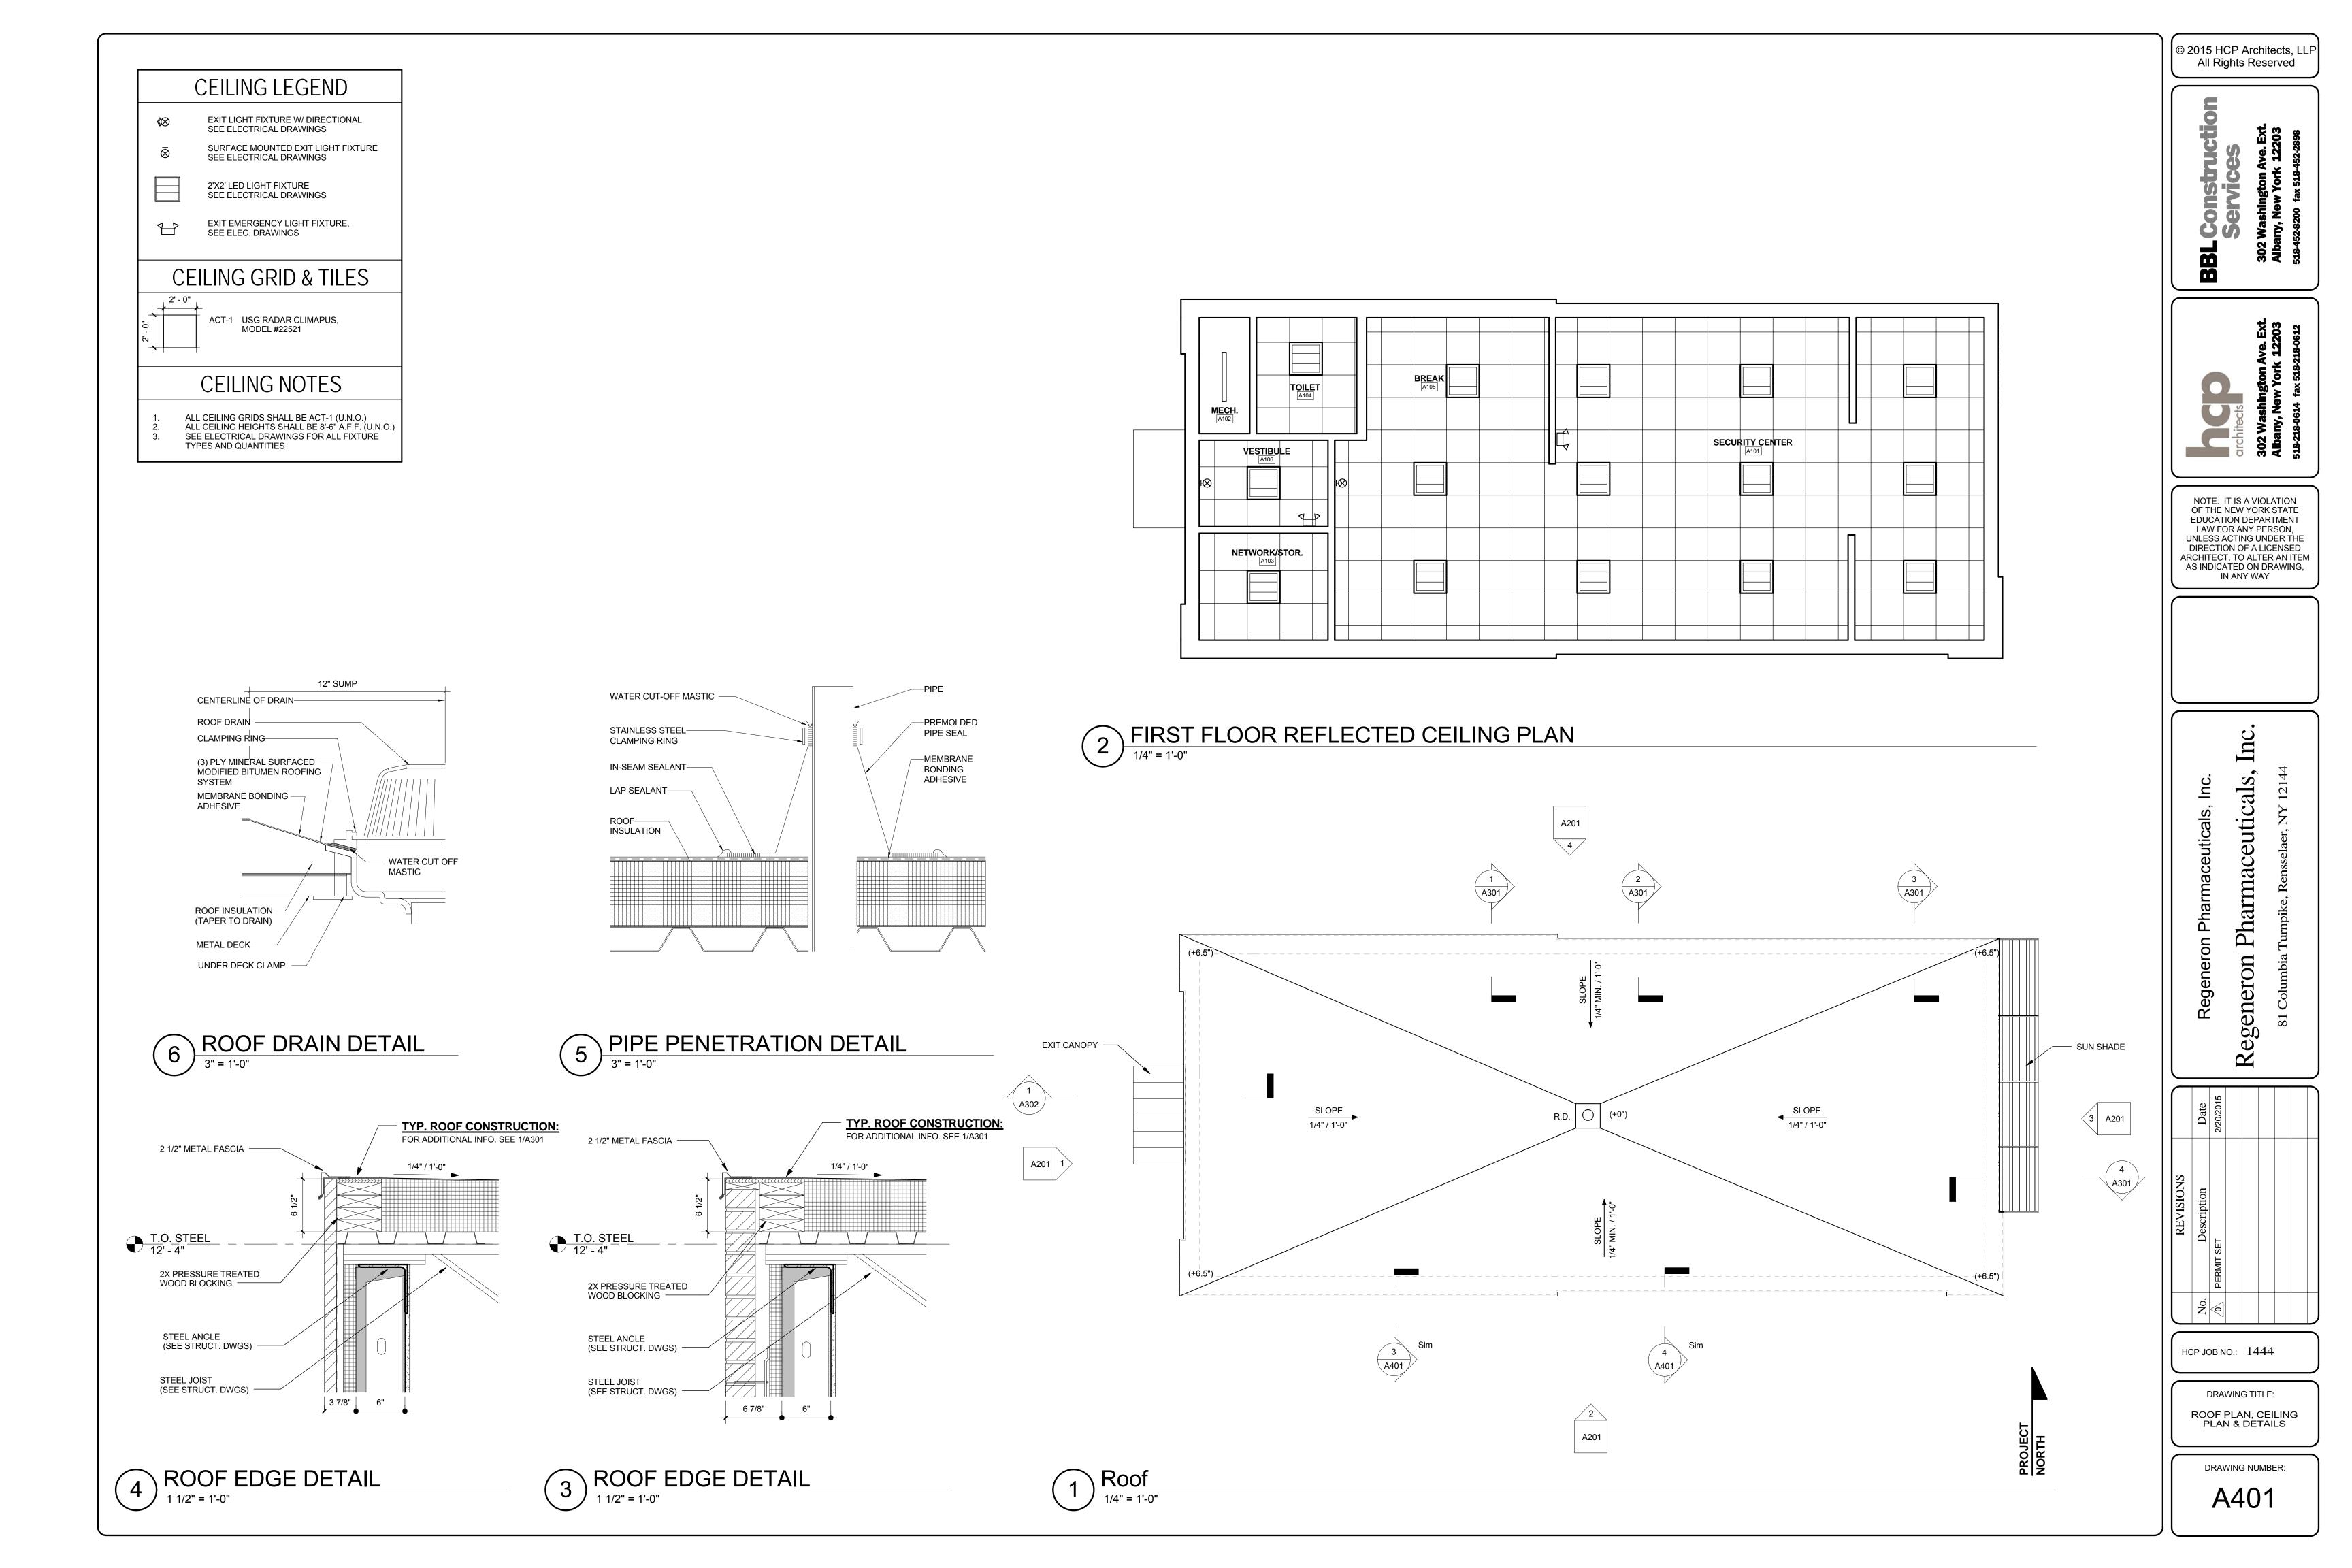
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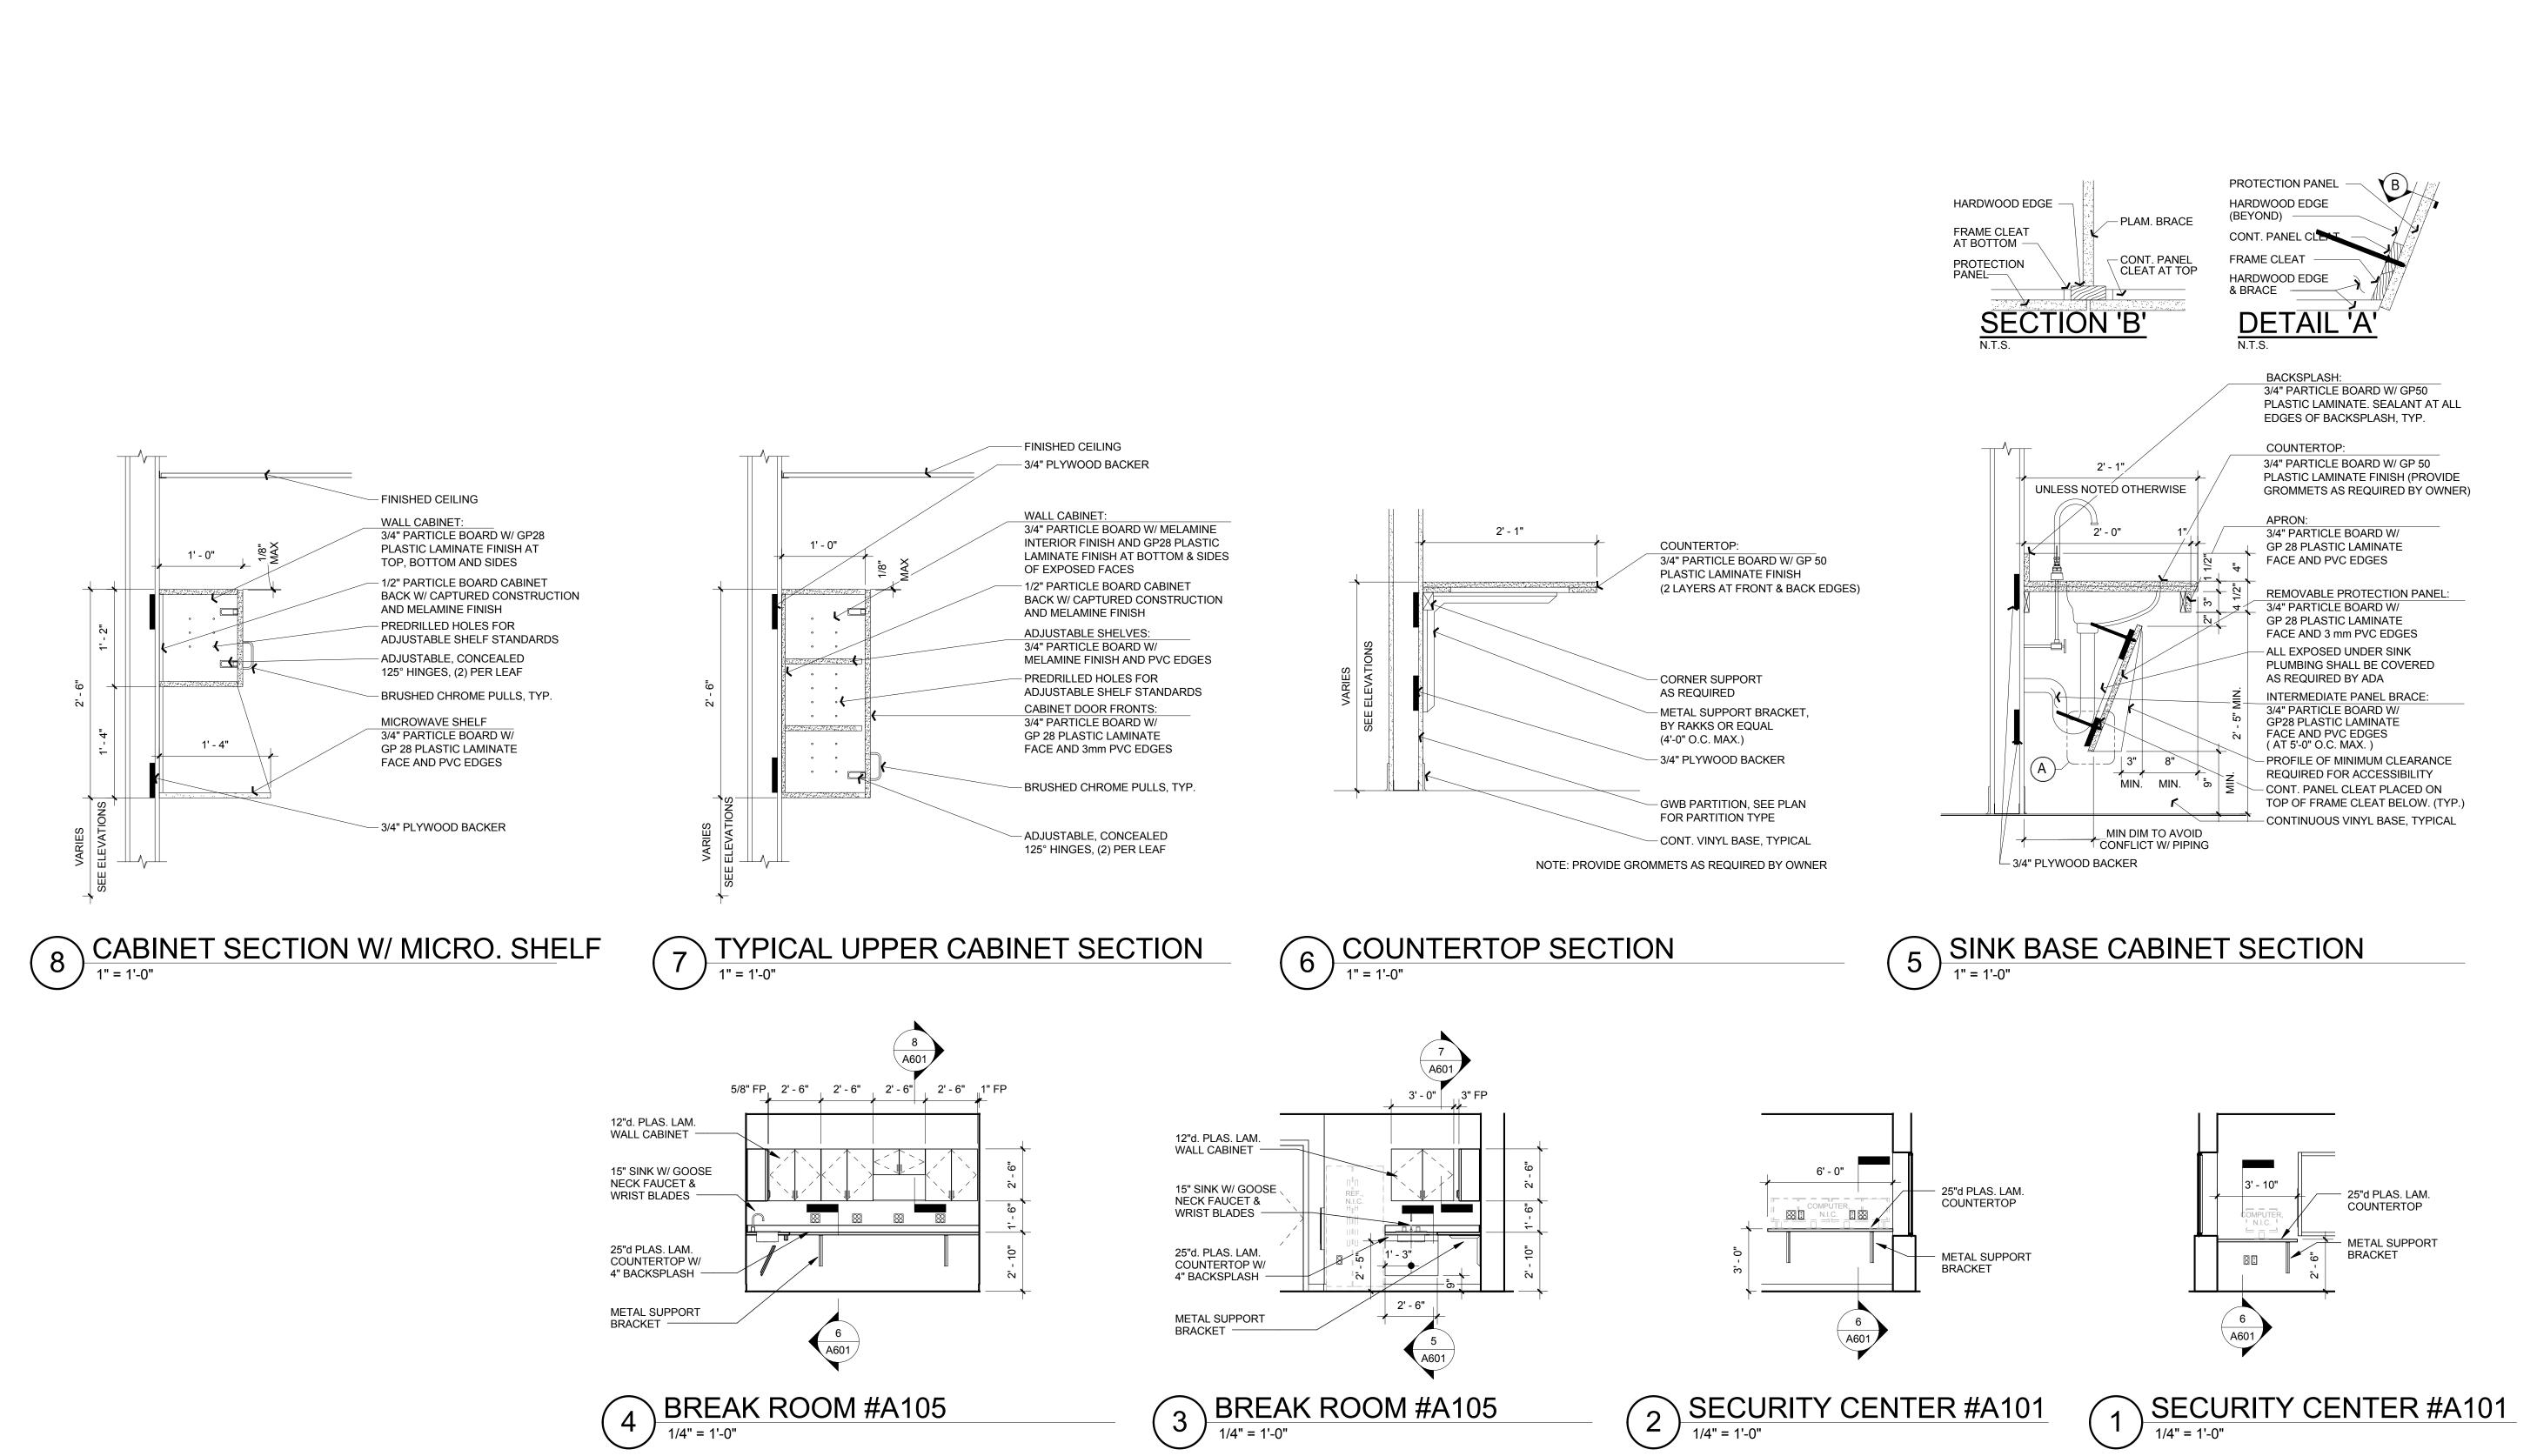
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DRAWING TITLE: WALL SECTIONS

DRAWING NUMBER:

A302






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DRAWING TITLE: INTERIOR ELEVATIONS & MILLWORK DETAILS

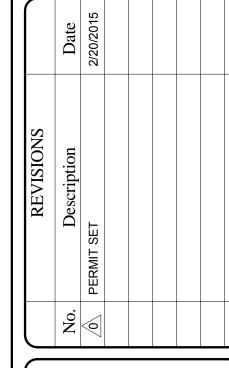DRAWING NUMBER:

A601