


Rev #	Date:	Description	Drawn By:	Rev #	Date:	Description	Drawn By:
А	08 Oct 2018	Issued for Permit	JR				
В	25 Oct 2018	ISSUED FOR PERMIT					

Scale:	1"=40
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WITHOUT THE PRIOR WRITTEN PERMISSION FROM REGENERON PHARMACEUTICALS, INC.


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File No.: 17-G-1201-D-10.D



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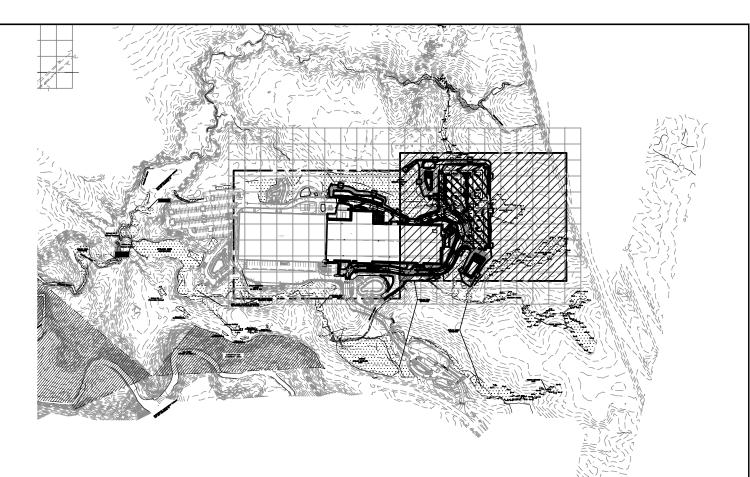
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Scale: 1"=40'

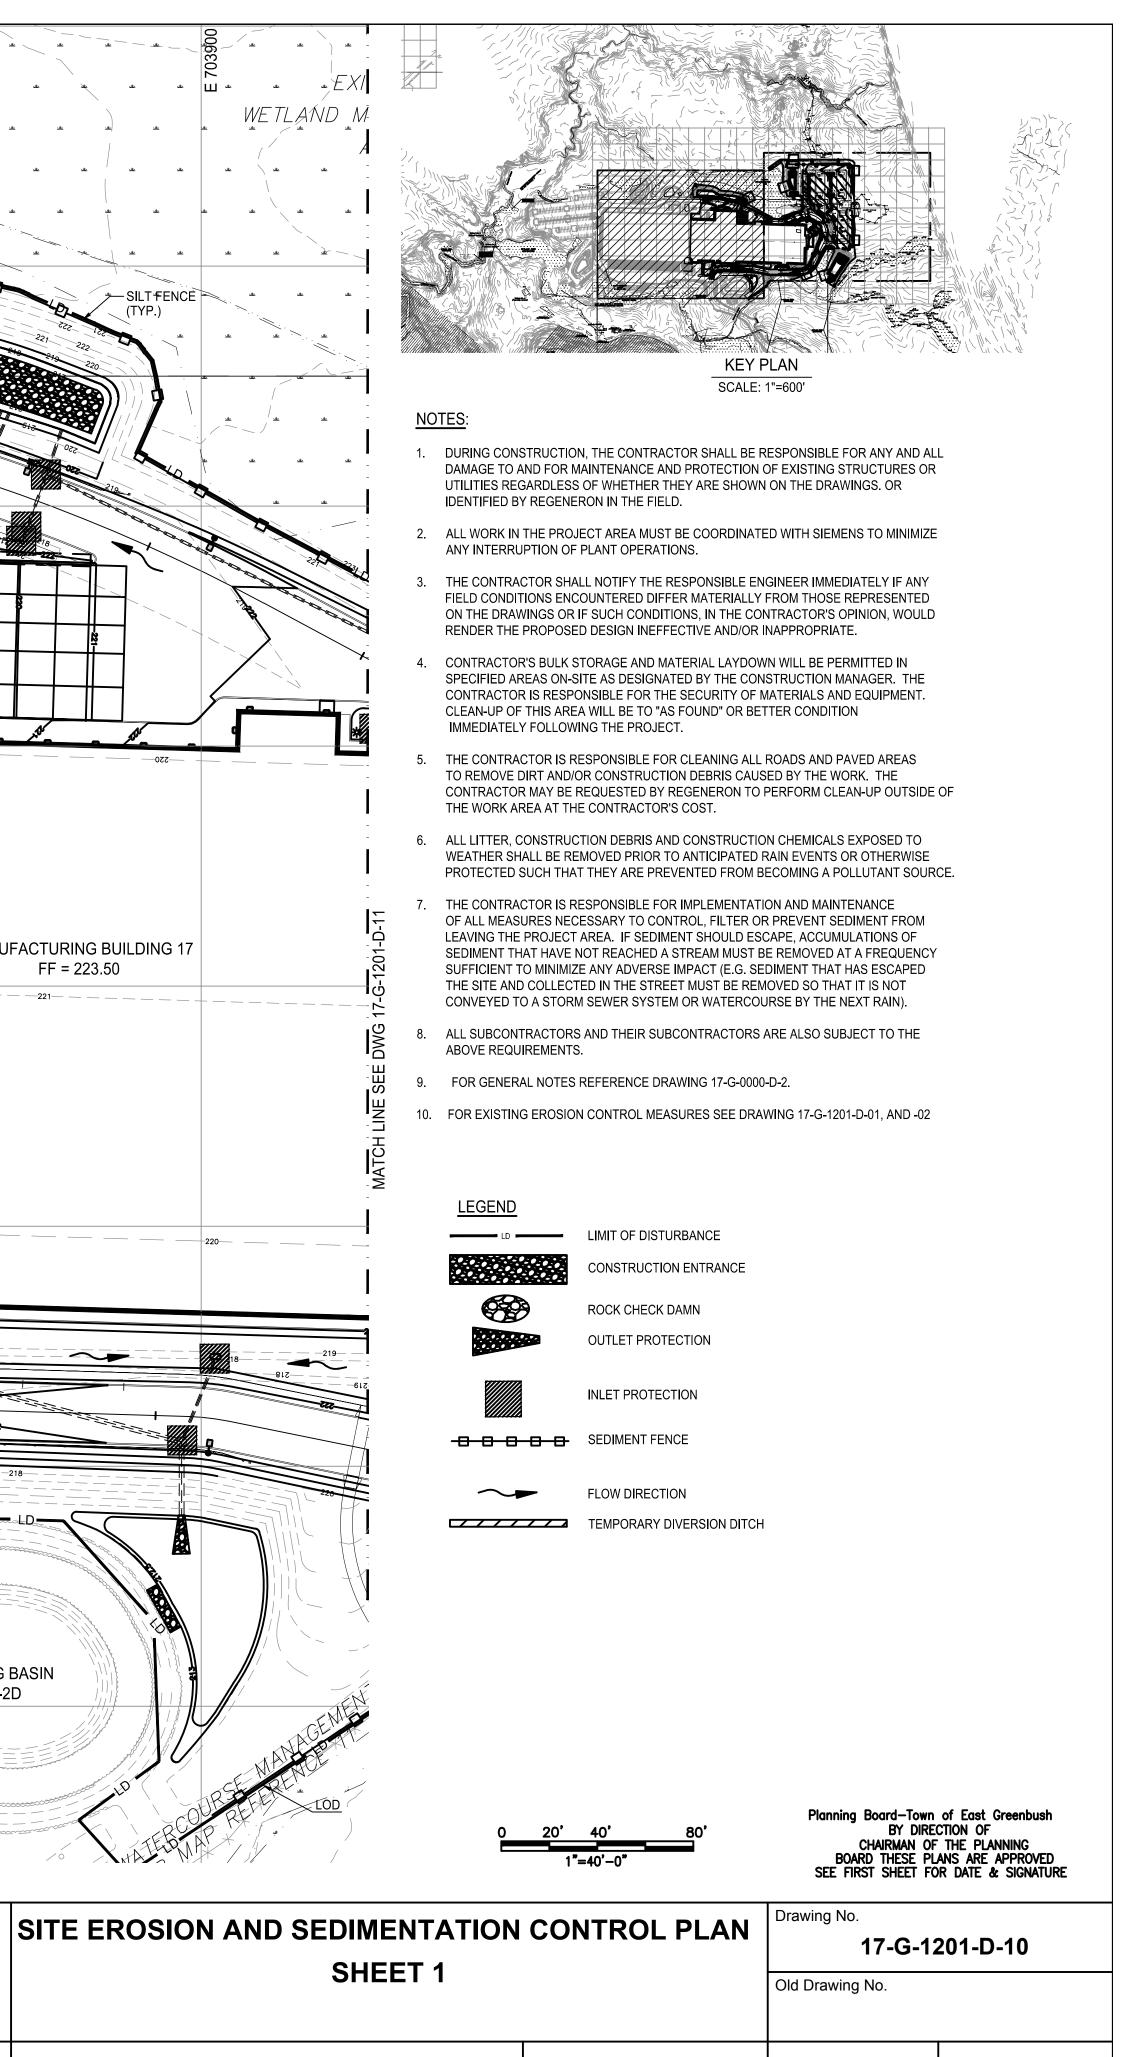FROM REGENERON PHARMACEUTICALS, INC.

Bldg.:

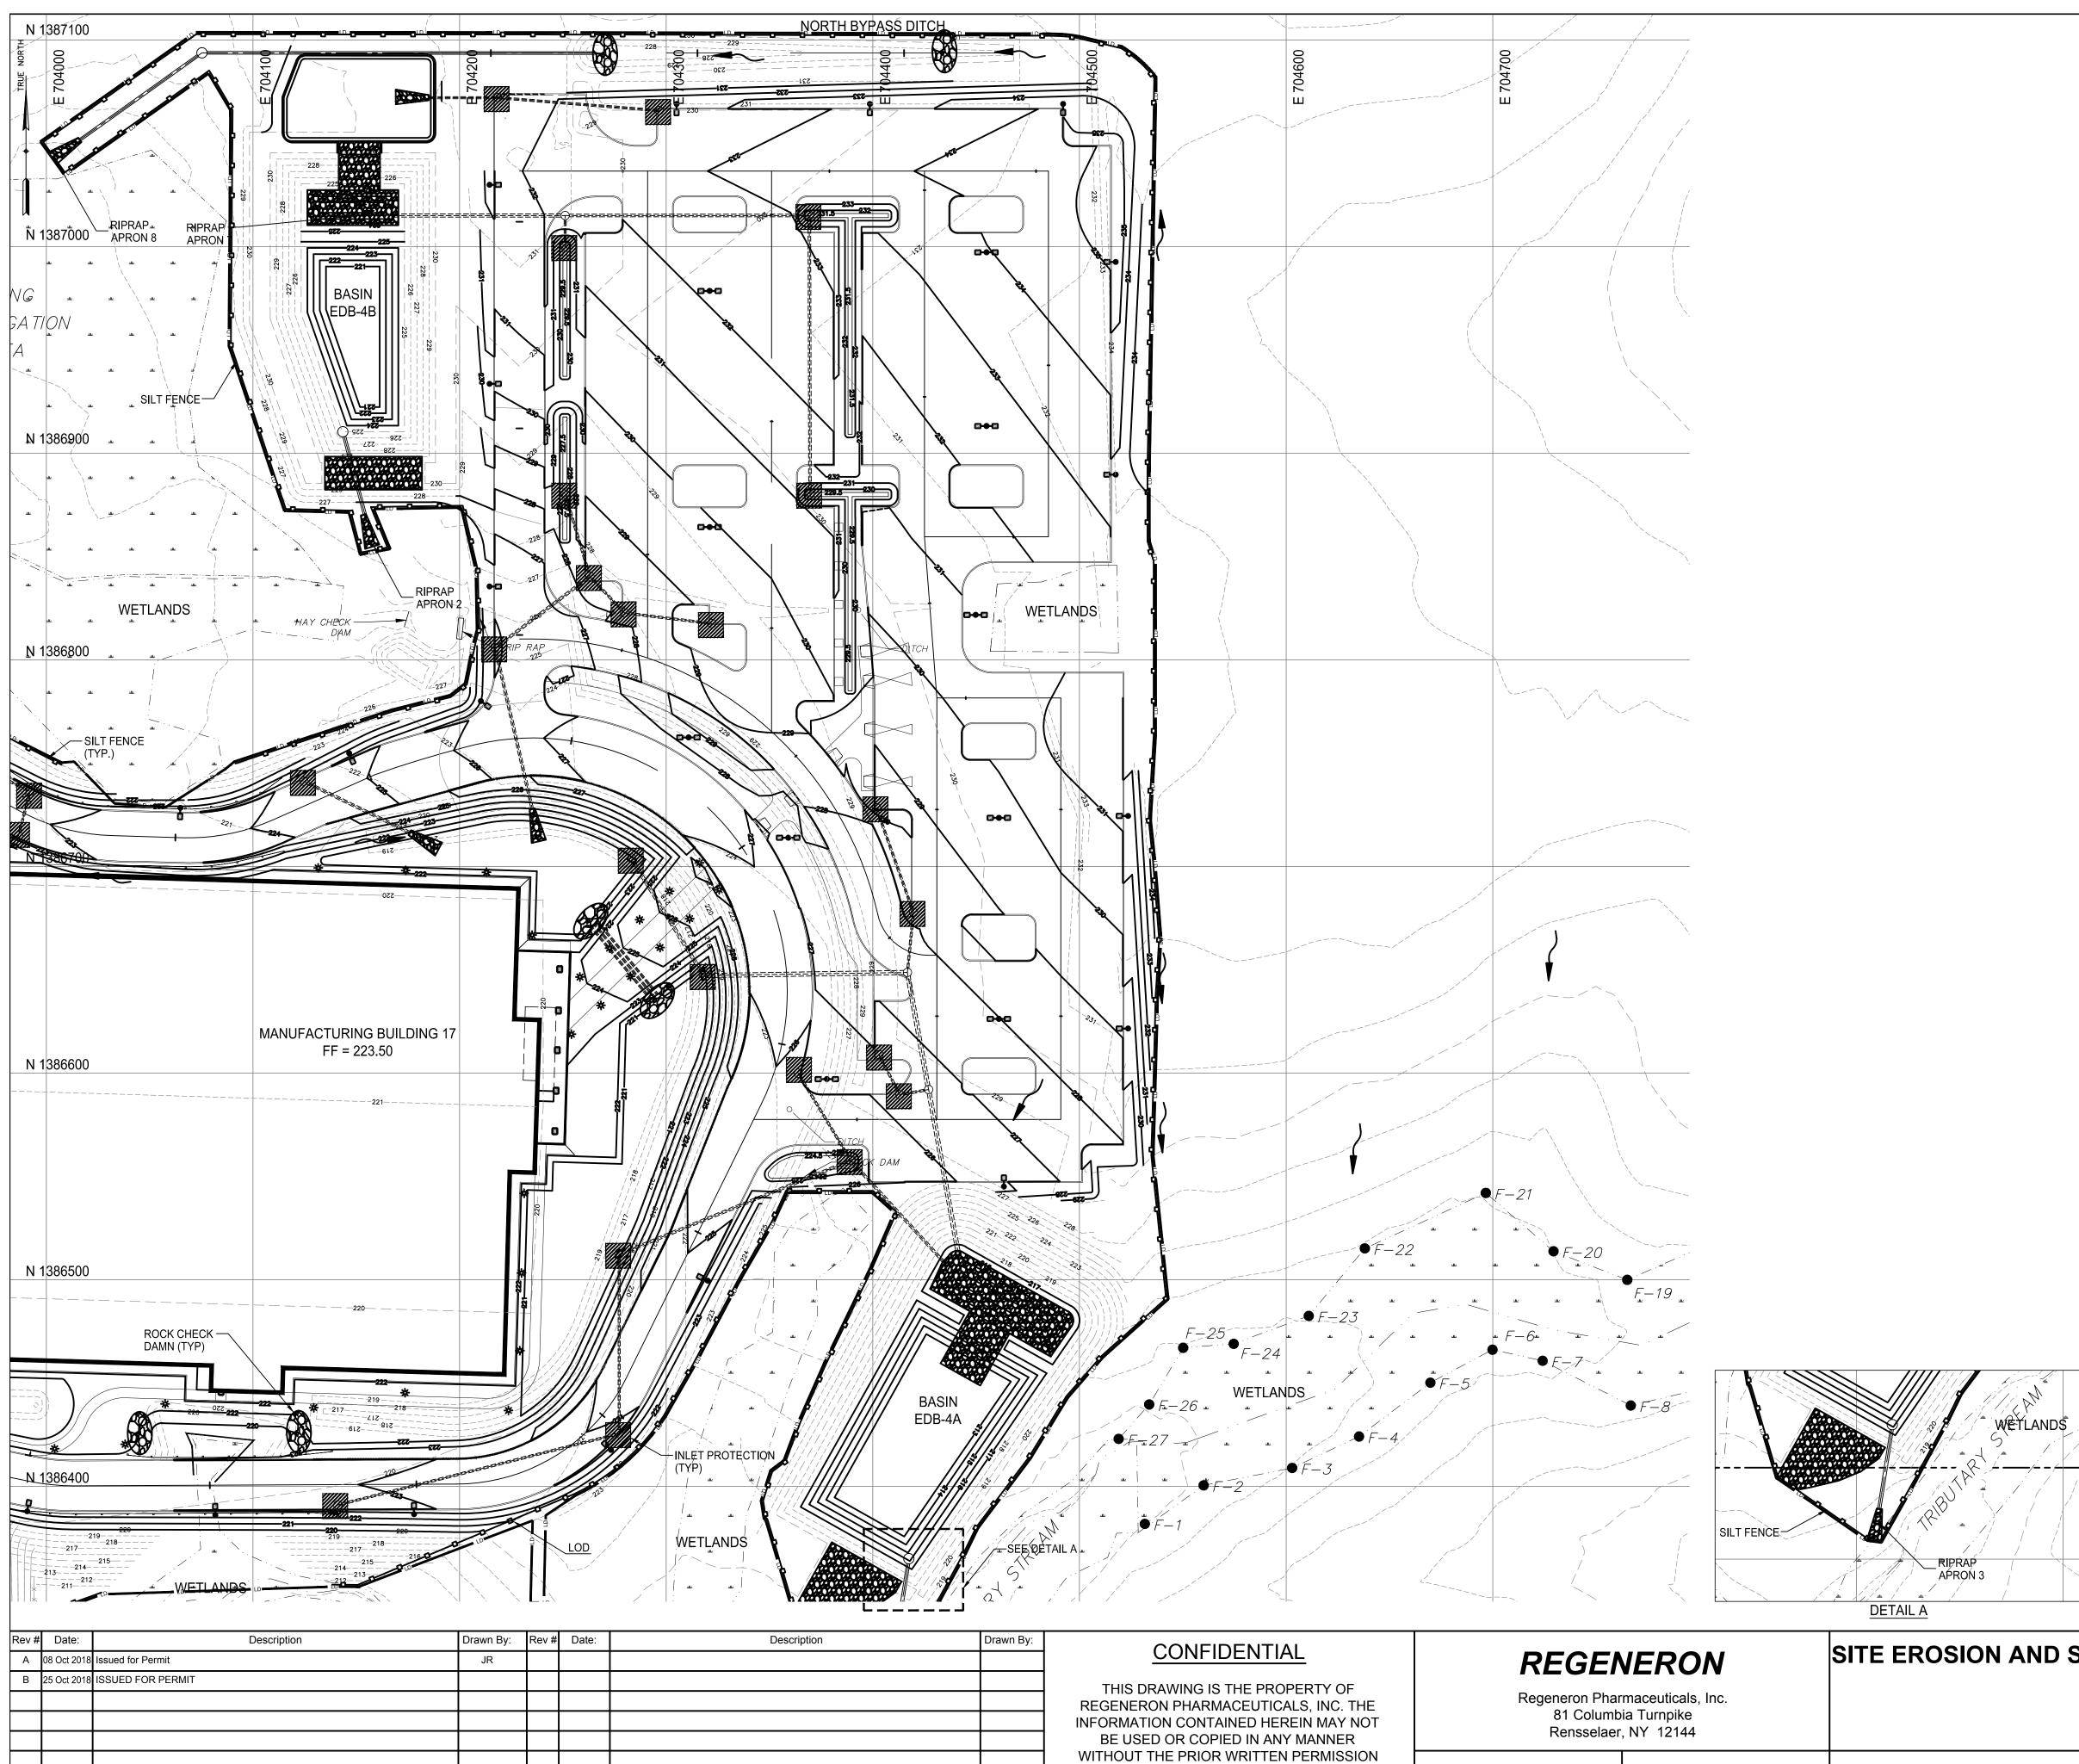File No.: 17-G-1201-D-11.DWG




KEY PLAN SCALE: 1"=600'

NOTES:

- 1. DURING CONSTRUCTION, THE CONTRACTOR SHALL BE RESPONSIBLE FOR ANY AND ALL DAMAGE TO AND FOR MAINTENANCE AND PROTECTION OF EXISTING STRUCTURES OR UTILITIES REGARDLESS OF WHETHER THEY ARE SHOWN ON THE DRAWINGS. OR IDENTIFIED BY REGENERON IN THE FIELD.
- 2. ALL WORK IN THE PROJECT AREA MUST BE COORDINATED WITH SIEMENS TO MINIMIZE ANY INTERRUPTION OF PLANT OPERATIONS.
- 3. THE CONTRACTOR SHALL NOTIFY THE RESPONSIBLE ENGINEER IMMEDIATELY IF ANY FIELD CONDITIONS ENCOUNTERED DIFFER MATERIALLY FROM THOSE REPRESENTED ON THE DRAWINGS OR IF SUCH CONDITIONS, IN THE CONTRACTOR'S OPINION, WOULD RENDER THE PROPOSED DESIGN INEFFECTIVE AND/OR INAPPROPRIATE.
- 4. CONTRACTOR'S BULK STORAGE AND MATERIAL LAYDOWN WILL BE PERMITTED IN SPECIFIED AREAS ON-SITE AS DESIGNATED BY THE CONSTRUCTION MANAGER. THE CONTRACTOR IS RESPONSIBLE FOR THE SECURITY OF MATERIALS AND EQUIPMENT. CLEAN-UP OF THIS AREA WILL BE TO "AS FOUND" OR BETTER CONDITION IMMEDIATELY FOLLOWING THE PROJECT.
- 5. THE CONTRACTOR IS RESPONSIBLE FOR CLEANING ALL ROADS AND PAVED AREAS TO REMOVE DIRT AND/OR CONSTRUCTION DEBRIS CAUSED BY THE WORK. THE CONTRACTOR MAY BE REQUESTED BY REGENERON TO PERFORM CLEAN-UP OUTSIDE OF THE WORK AREA AT THE CONTRACTOR'S COST.
- 6. ALL LITTER, CONSTRUCTION DEBRIS AND CONSTRUCTION CHEMICALS EXPOSED TO WEATHER SHALL BE REMOVED PRIOR TO ANTICIPATED RAIN EVENTS OR OTHERWISE PROTECTED SUCH THAT THEY ARE PREVENTED FROM BECOMING A POLLUTANT SOURCE.
- 7. THE CONTRACTOR IS RESPONSIBLE FOR IMPLEMENTATION AND MAINTENANCE OF ALL MEASURES NECESSARY TO CONTROL, FILTER OR PREVENT SEDIMENT FROM LEAVING THE PROJECT AREA. IF SEDIMENT SHOULD ESCAPE, ACCUMULATIONS OF SEDIMENT THAT HAVE NOT REACHED A STREAM MUST BE REMOVED AT A FREQUENCY SUFFICIENT TO MINIMIZE ANY ADVERSE IMPACT (E.G. SEDIMENT THAT HAS ESCAPED THE SITE AND COLLECTED IN THE STREET MUST BE REMOVED SO THAT IT IS NOT CONVEYED TO A STORM SEWER SYSTEM OR WATERCOURSE BY THE NEXT RAIN).
- 8. ALL SUBCONTRACTORS AND THEIR SUBCONTRACTORS ARE ALSO SUBJECT TO THE ABOVE REQUIREMENTS.
- 9. FOR GENERAL NOTES REFERENCE DRAWING 17-G-0000-D-2.
- 10. FOR EXISTING EROSION CONTROL MEASURES SEE DRAWING 17-G-1201-D-01, AND -02

	LEGEND				
	LD	LIMIT OF DIS	TURBANCE		
		CONSTRUCT	ION ENTRANCE		
		ROCK CHEC			
		INLET PROTE	ECTION		
<u></u>		SEDIMENT F	ENCE		
	\sim	FLOW DIREC	TION		
		TEMPORARY	/ DIVERSION DITCH		
0 20' 40 1"=40'-			Planning Board—Town of BY DIRECTIO CHAIRMAN OF TH BOARD THESE PLANS SEE FIRST SHEET FOR D	N OF	
SEDIMENTATION	CONTROL P	PLAN Drawing No. 17-G-1201-D-11			
SHEET 2			Old Drawing No.		
G	Date: 30/10/2018		Revision: B	Sheet:	

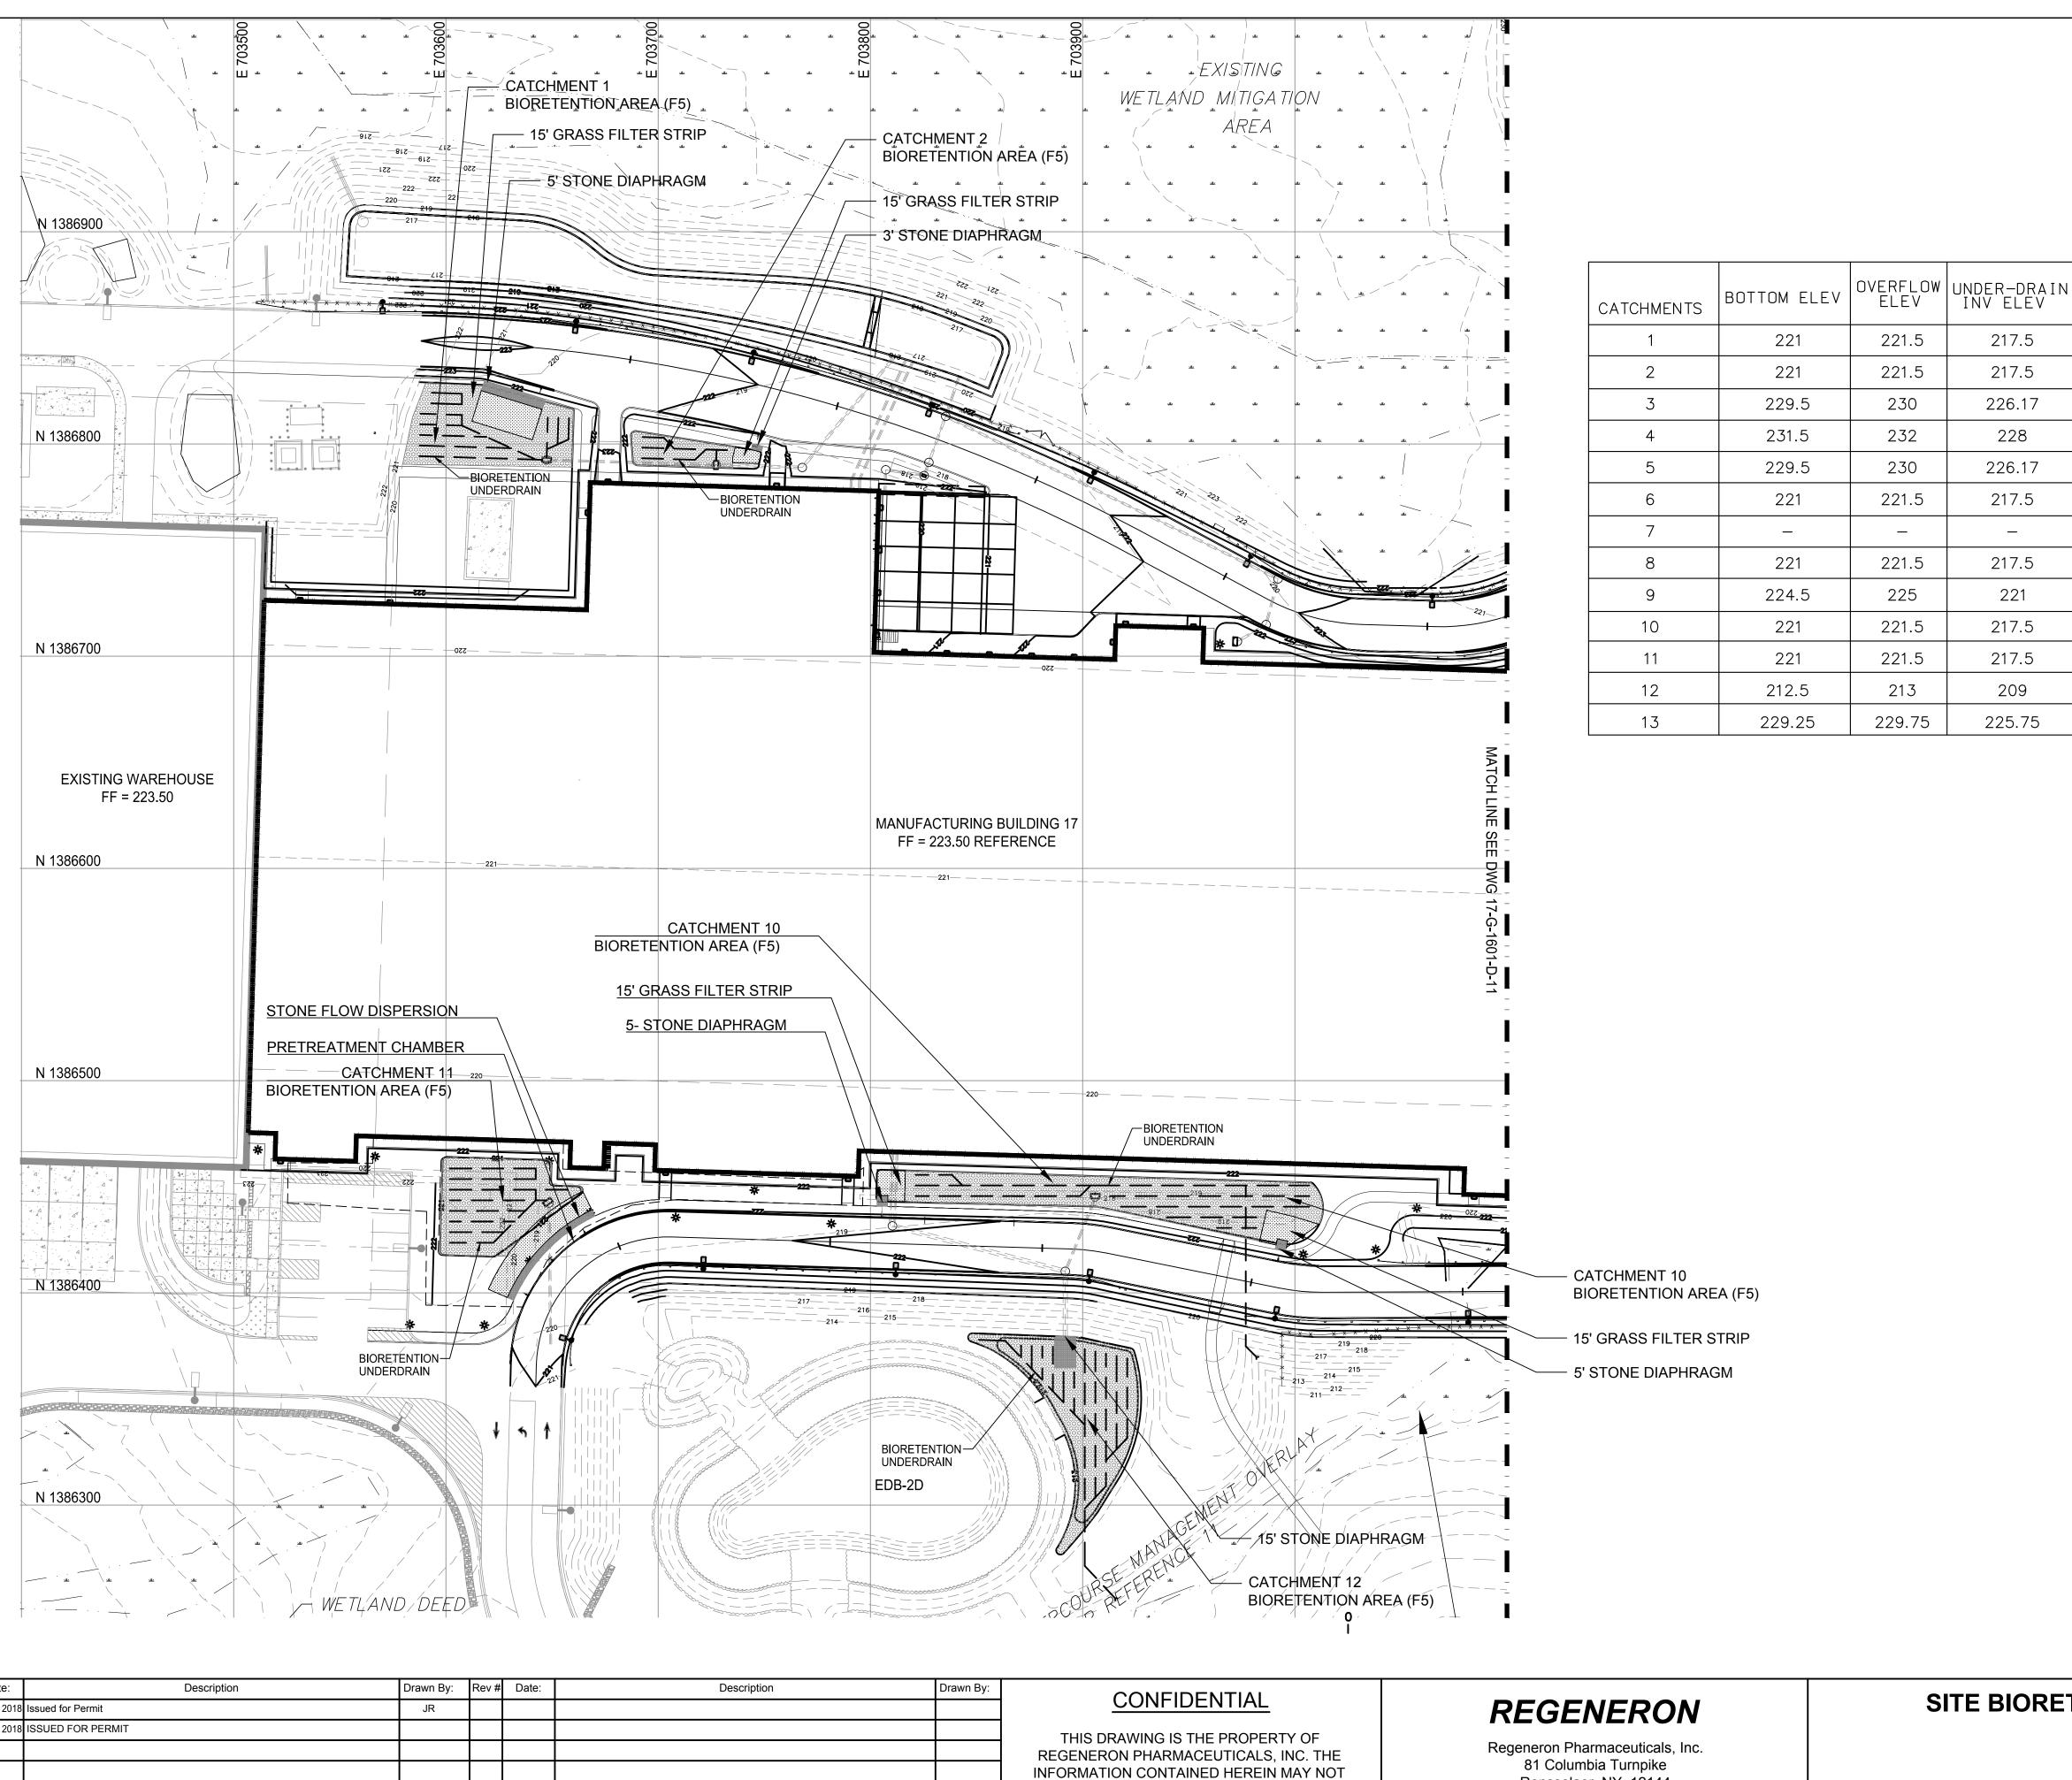

Rev #	Date:	Description	Drawn By:	Rev #	Date:	Description	Drawn By:			
Α	08 Oct 2018	Issued for Permit	JR							
В	25 Oct 2018	ISSUED FOR PERMIT								


Scale: 1"=30'

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Bldg.:

Rensselaer, NY 12144

File No.: 17-G-1601-D-10.DWG

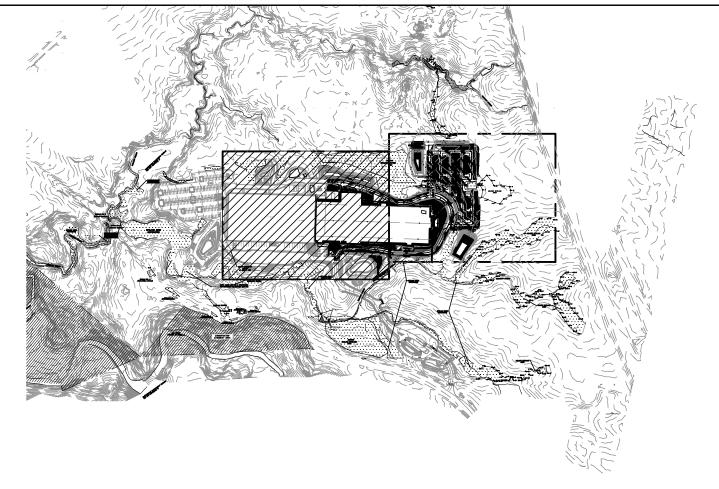

KEY PLAN SCALE: 1"=600'

NOTES:


228


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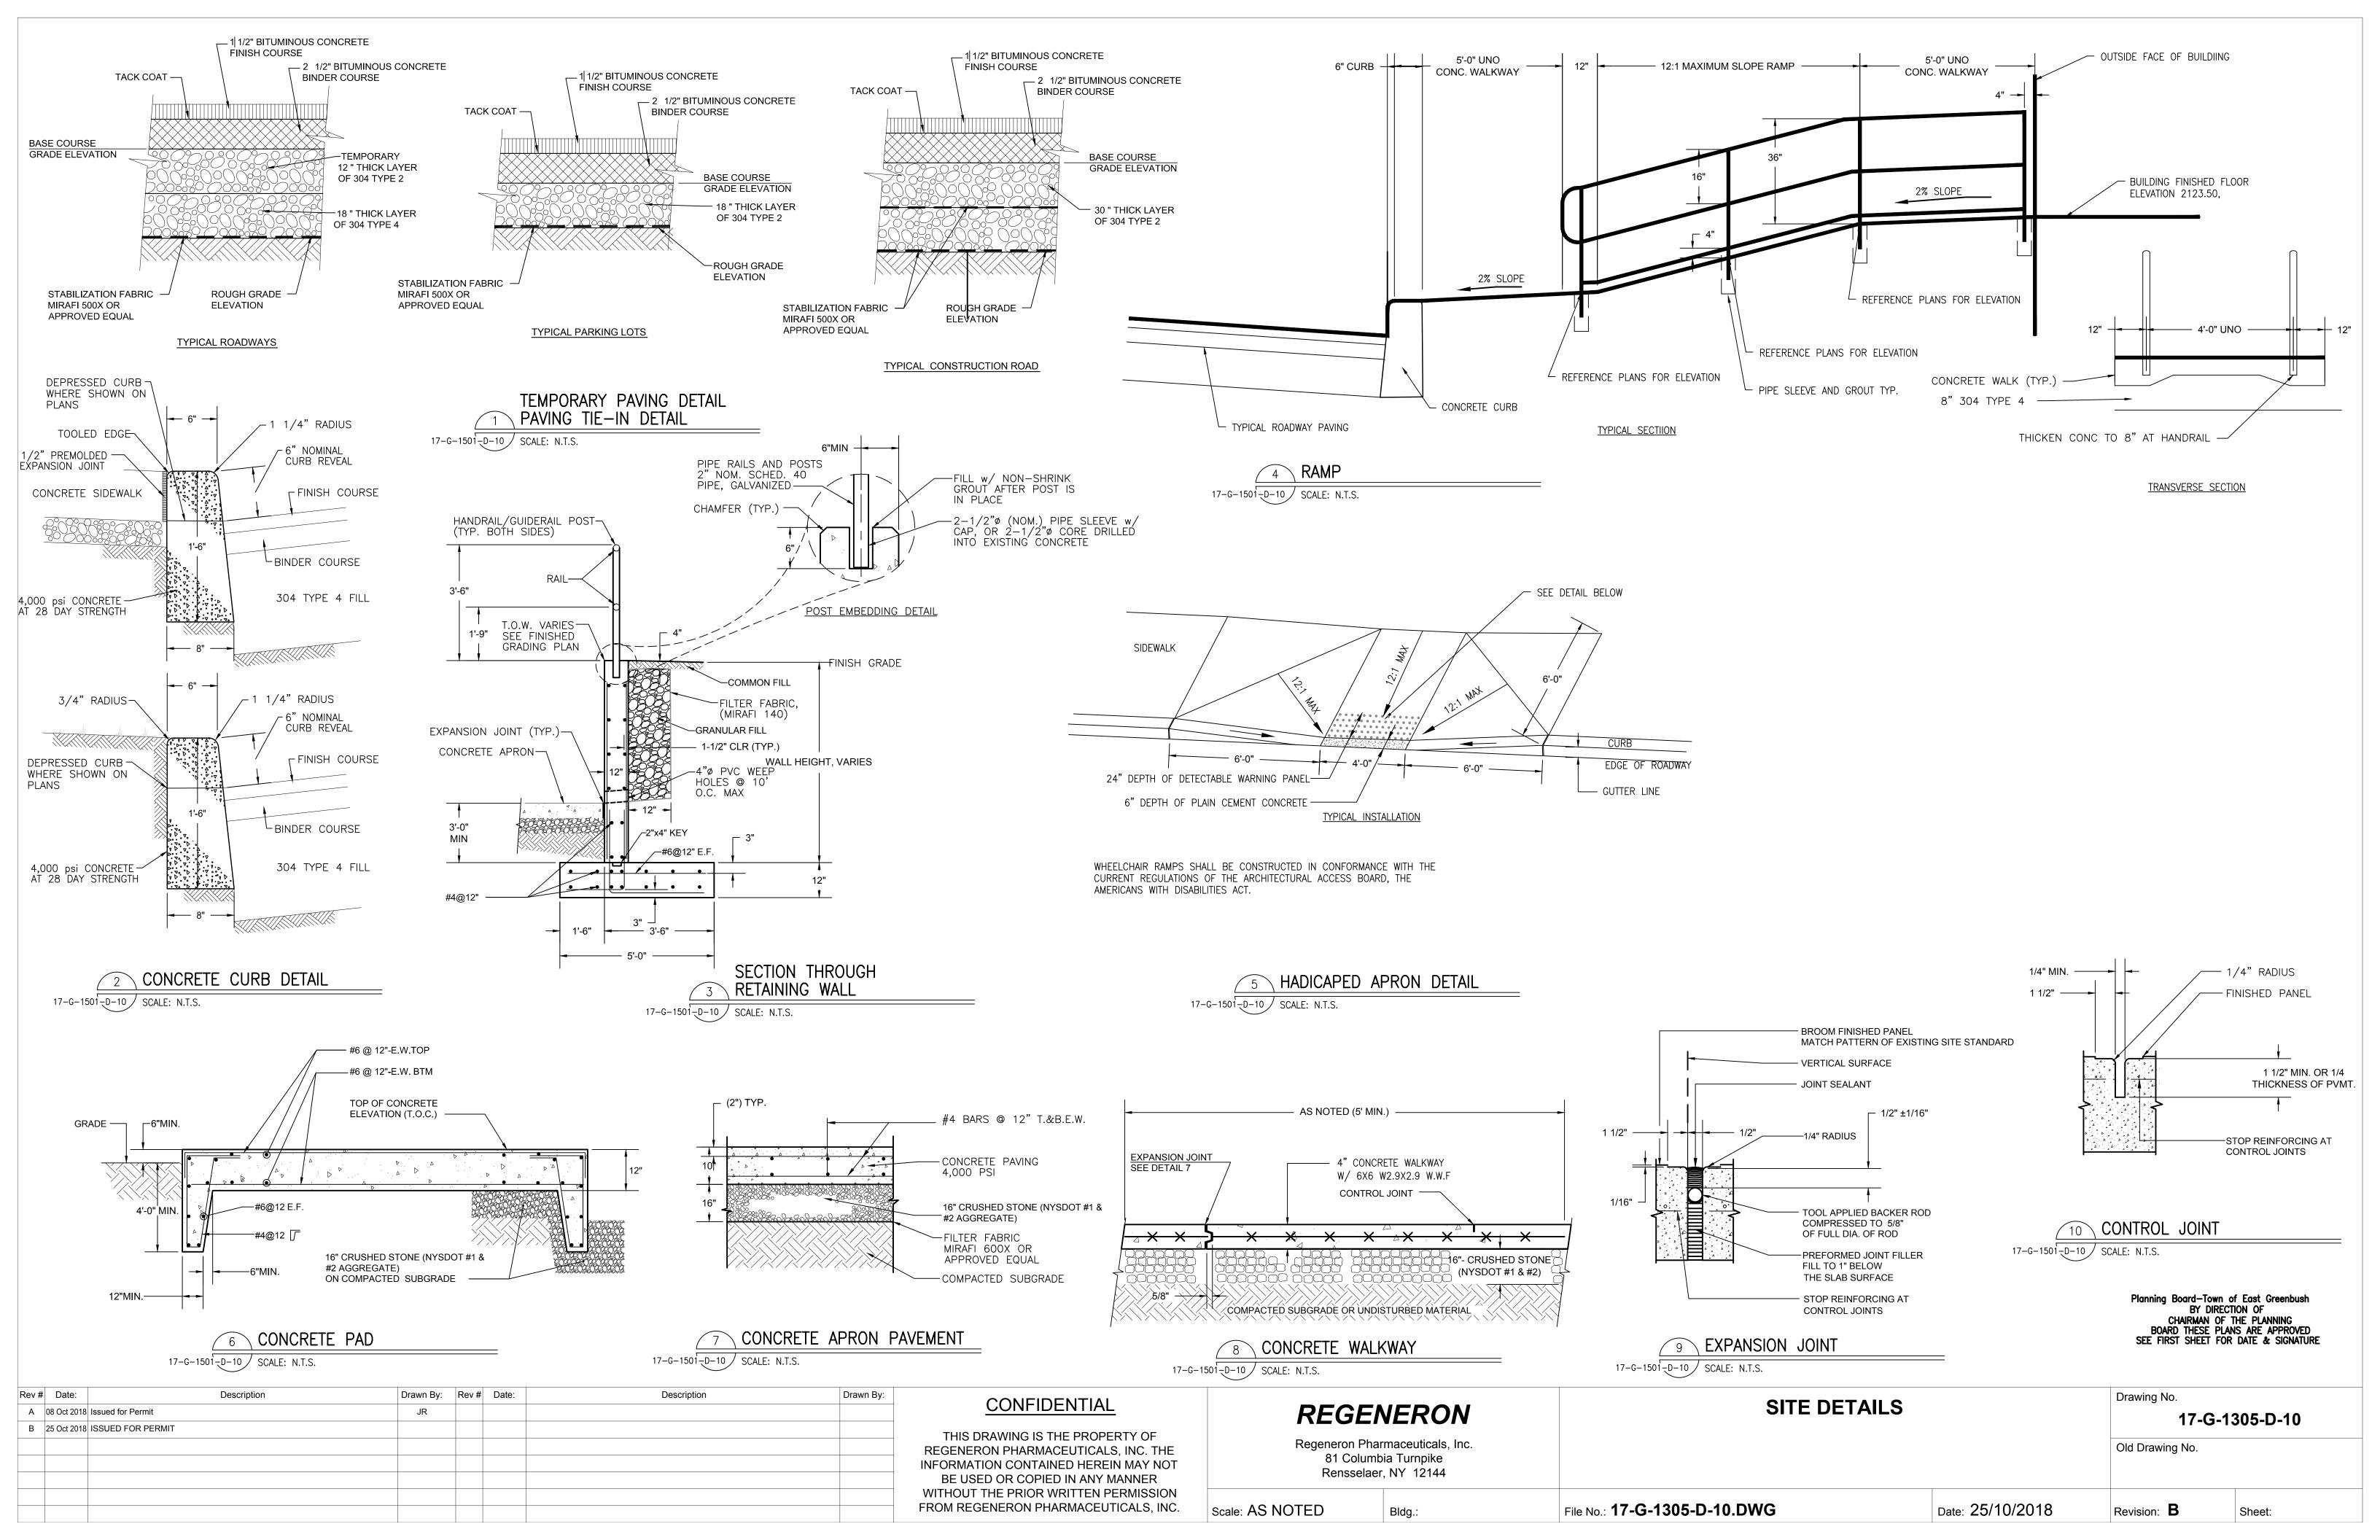
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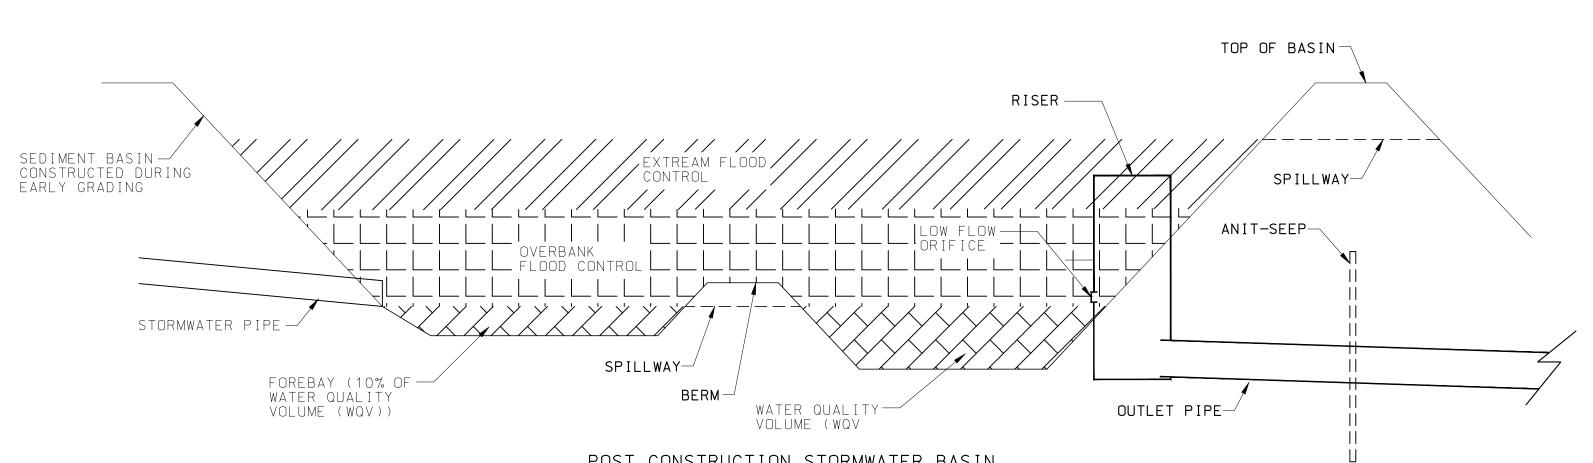
209

- FOR GENERAL NOTES AND LEGEND SEE DRAWING. 17-G-0000-D-2.
- SITE LAYOUT PLANS REFERENCE DRAWING 17-G-1301-D-30, 31,40 AND 41. REFERENCE DRAWING 17-G-1301-D-10 AND 11 FOR SITE GRADING PLANS
- REFERENCE DRAWING 17-G-1305-D-10 FOR SITE DETAIL
- FOR GUIDE RAIL DETAILS REFERENCE STATE OF NEW YORK D.O.T. WEEK POST CORRUGATED-BEAM GUIDE RAIL DRAWINGS, SHEETS 1, 2 AND 3 - 606-07
- DIMENSION TO BUILDING IS TO FACE OF BUILDING U.N.O. DIMENSIONS TO CURB IS TO FACE OF CURB
- TYPICAL PARKING STALL DIMENSIONS IS 18'-0" IN DEPTH AND 9'-4" IN WIDTH
- FOR ZONING INFORMATION REFERENCE DRAWING 17-G-000-D-10
- 10. REFERENCE DRAWINGS 17G-1501-D-12 AND 13 FOR STORM SEWER STRUCTURE LOCATION AND STORM SEWER PIPING
- 11. REFERENCE DRAWING 17-G-1302-D-10 FOR ROAD PROFILES 12. INFORMATION SHOWN FOR THE EXISTING WAREHOUSE BUILDING AND
- SURROUNDING SITE IMPROVEMENTS REFLECT AS-DESIGNED DOCUMENTS AND MAY NOT ACCURATELY REFLECT AS-BUILT INFORMATION. CONTRACTOR TO VERIFY ALL RELEVANT INFORMATION REGARDING THE WAREHOUSE AND SURROUNDING SITE IMPROVEMENTS PRIOR TO CONSTRUCTION
- 13. DRAWINGS SHOW EARLY GRADING AS DESIGNED INFORMATION AS EXISTING. REFERENCE BUILDING 17 EARLY GRADING PERMIT PACKAGE FOR EARLY GRADING INFORMATION.
- 14. INFORMATION CONCERNING SITE TOPOGRAPHY, EXISTING UTILITIES, PROPERTY LINE AND WETLANDS HAS BEEN PROVIDED BY REGENERON.
- 15. SITE PROPERTY LINE ASSUMES THAT LOTS OWNED BY REGENERON HAVE BEEN CONSOLIDATED INTO A SINGLE LOT.
- 16. REFERENCE DRAWING 17-G-000-D-2 FOR GENERAL NOTES 17. BASIS OF BEARINGS IS NEW YORK STATE PLANE COORDINATES SYSTEM EAST ZONE. HORIZONTAL DATUM IS NAD83
- 18. REFERENCE ARCHITECTURAL DRAWINGS FOR BUILDING LAYOUT INFORMATION 19. DURING CONSTRUCTION, THE CONTRACTOR SHALL BE RESPONSIBLE FOR ANY AND ALL DAMAGE TO AND FOR MAINTENANCE AND PROTECTION OF EXISTING STRUCTURES OR UTILITIES REGARDLESS OF WHETHER THEY ARE SHOWN ON THE DRAWINGS OR IDENTIFIED BY REGENERON IN THE FIELD
- 20. ALL GRADING WORK IN THE PROJECT AREA SHALL BE COORDINATED WITH **REGENERON TO MINIMIZE INTERRUPTIONS TO EXISTING OPERATIONS**
- 21. THE CONTRACTOR SHALL NOTIFY THE RESPONSIBLE ENGINEER IMMEDIATELY IF ANY FIELD CONDITIONS ENCOUNTERED DIFFER MATERIALLY FROM THOSE REPRESENTED ON THE DRAWINGS OR IF SUCH CONDITIONS, IN THE CONTRACTOR'S OPINION, WOULD RENDER THE PROPOSED DESIGN INEFFECTIVE AND/OR INAPPROPRIATE
- 22. REFERENCE DRAWINGS 17-G-1601-D-10 AND 11 FOR INFORMATION ON **BIORETENTION AREAS**
- 23. EXISTING GRADES REFLECT AS DESIGNED EARLY GRADING, REFERENCE DRAWINGS 17-G-1301-D-5 AND 6 FOR ROUGH GRADE ELEVATIONS
- 24. REFERENCE DRAWINGS 17-G-1201-D-1 AND 2 FOR INITIAL EROSION AND SEDIMENTATION CONTROL PLANS
- 25. ALL CONSTRUCTION STONE SURFACE AREAS ARE TEMPORARY, AND SHALL BE RESTORED TO GRASS SURFACE CONDITIONS WITHIN 6 MONTH OF PROJECT COMPLETION.
- 26. REFERENCE NEW YORK STATE STORMWATER MANAGEMENT DESIGN MANUAL FOR ADDITIONAL REQUIREMENTS CONCERNING BIORETENTION AREAS CHAPTER 6 SECTION 6.4 STORMWATER FILTERING SYSTEMS





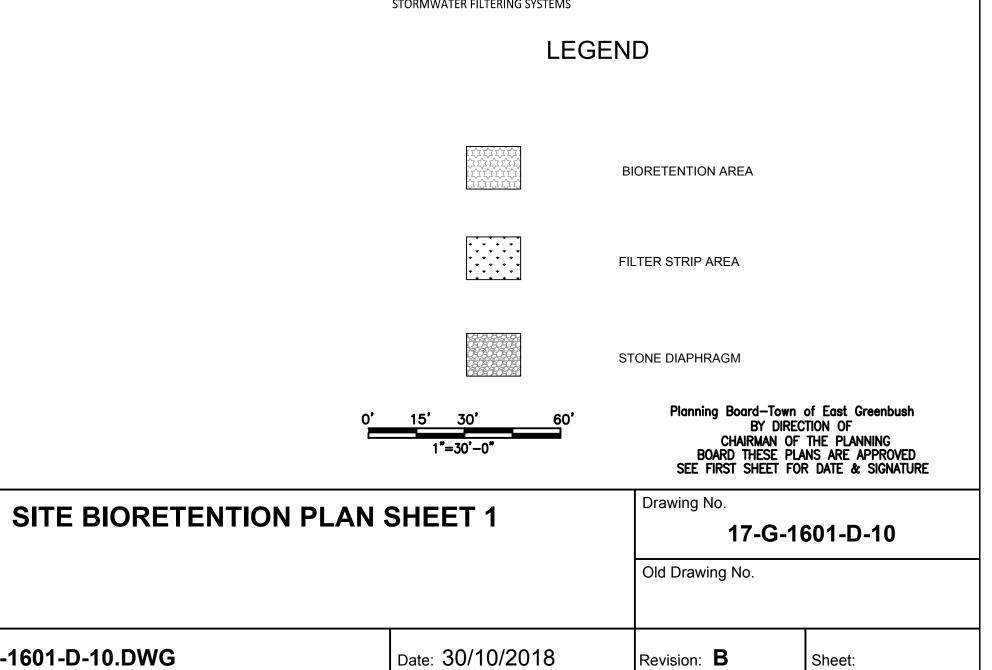

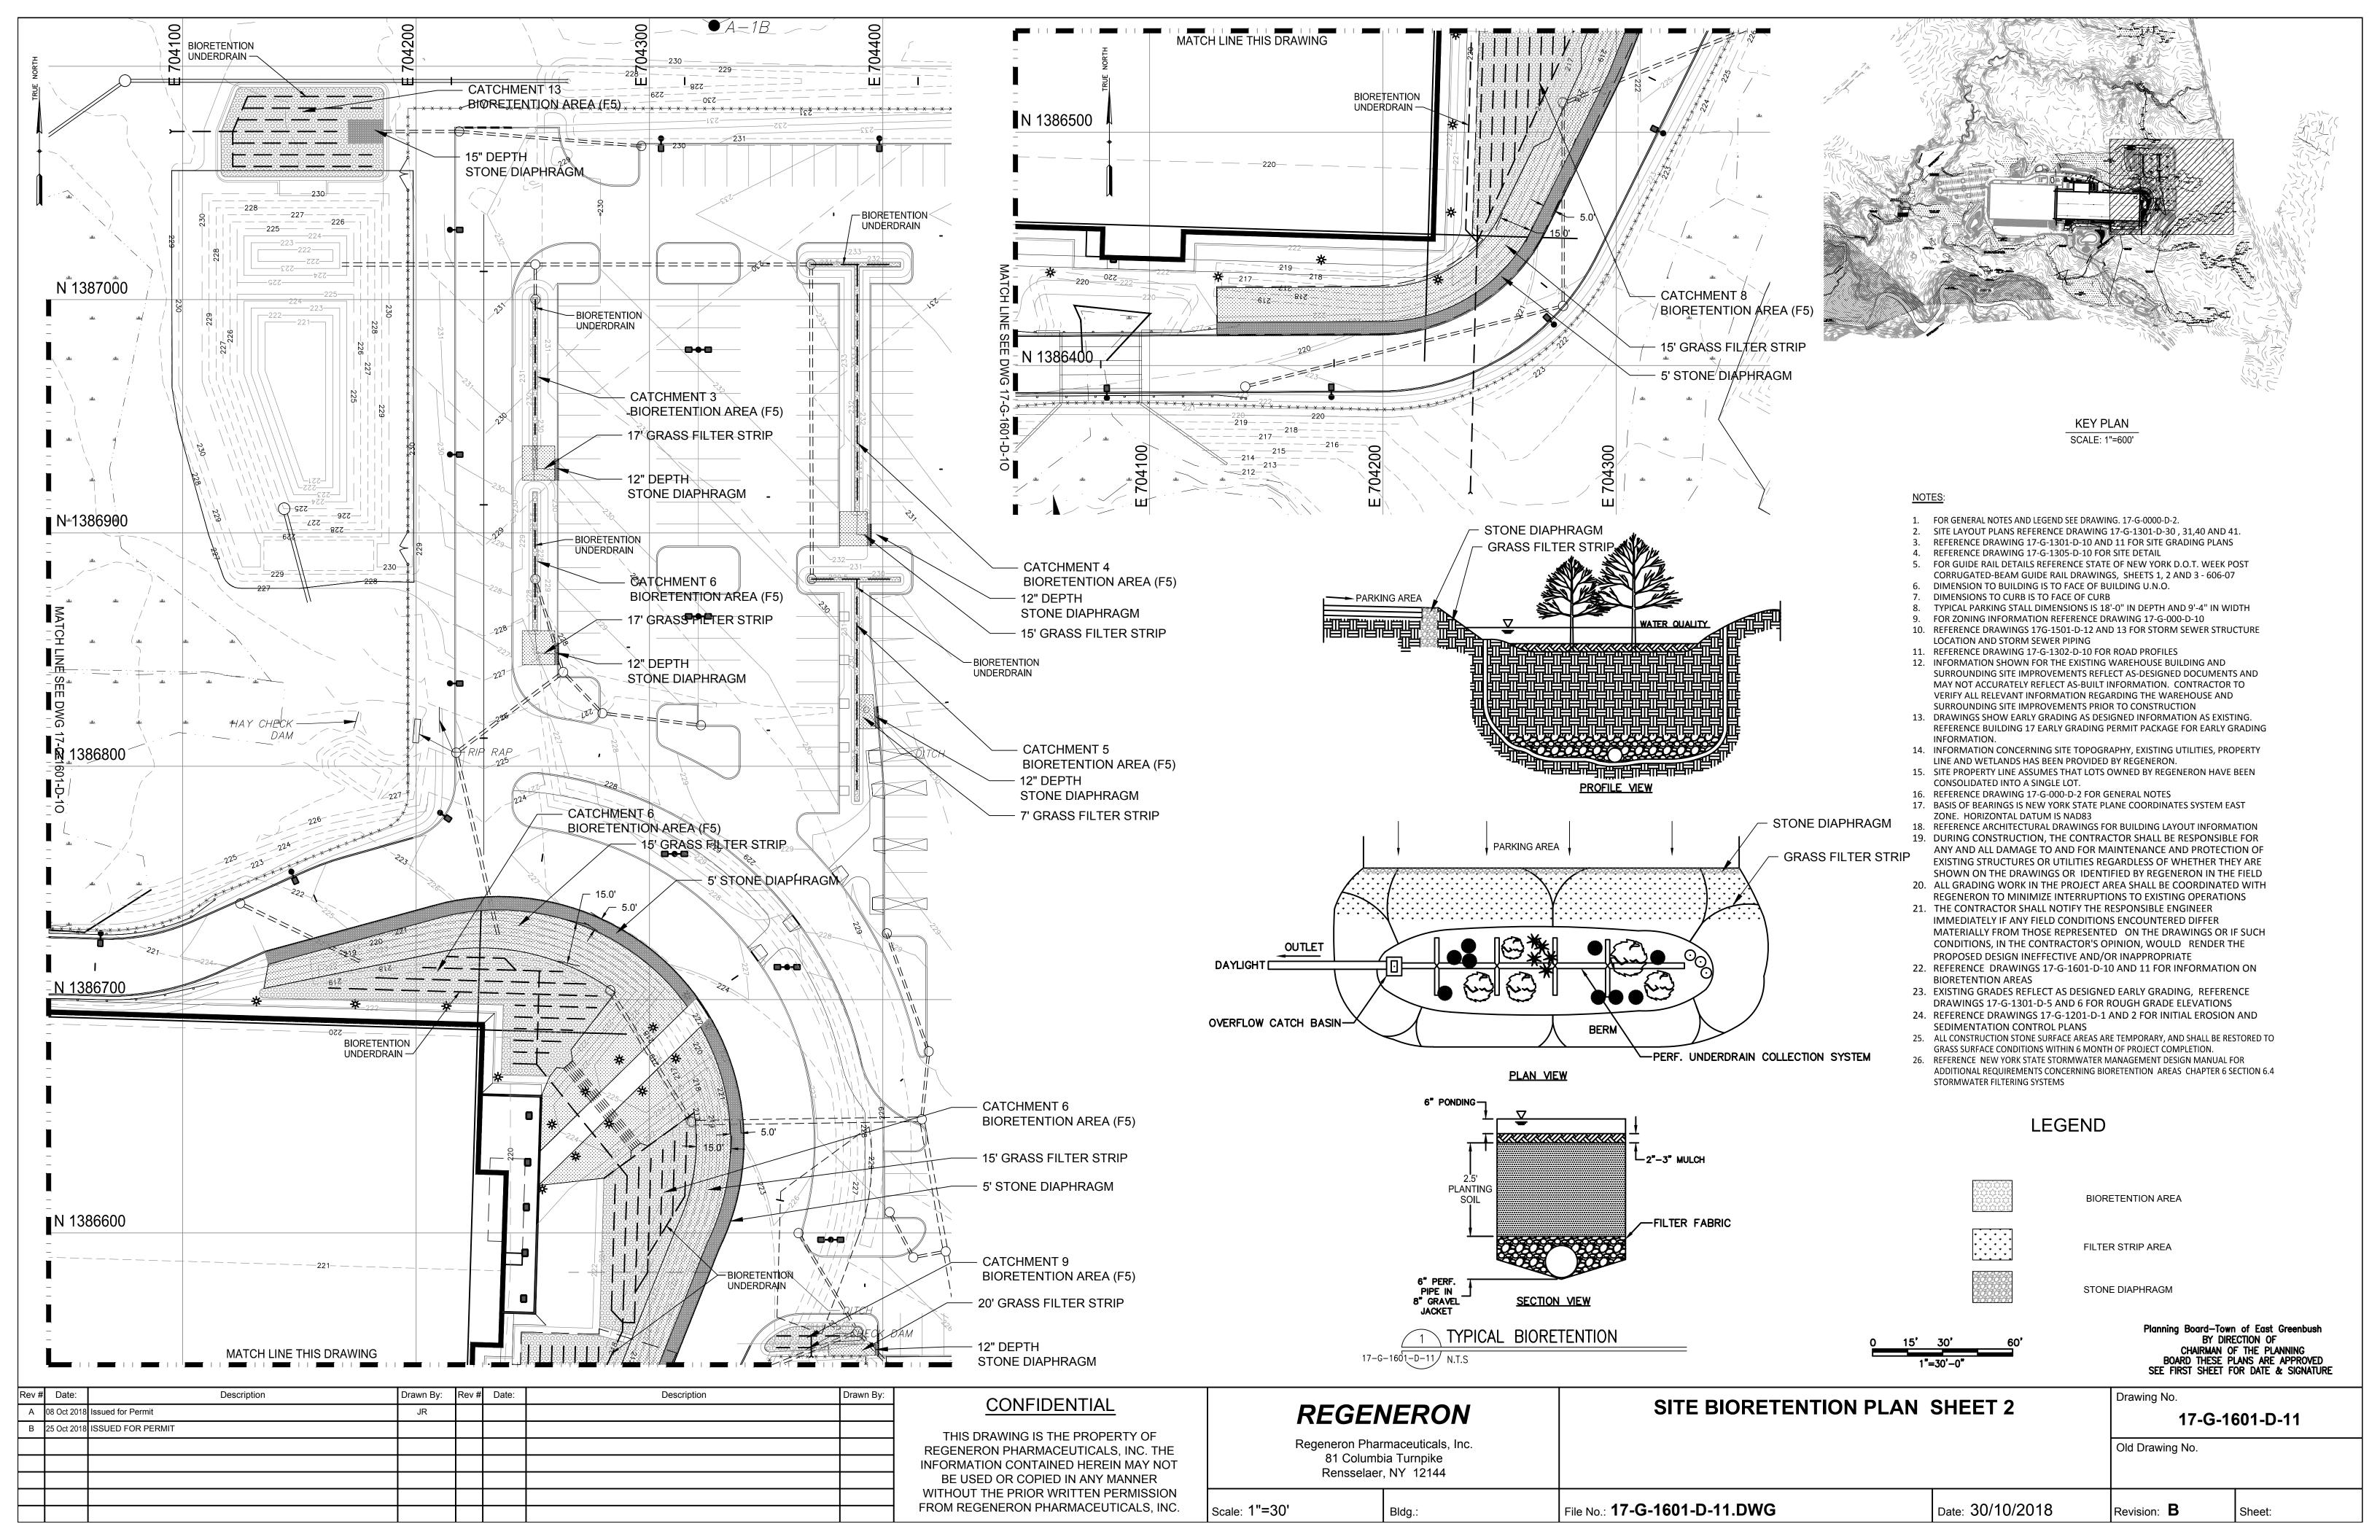

POST CONSTRUCTION STORMWATER BASIN N.T.S.


BASIN	BASIN 4A	BASIN 4B	BASIN 4C
BOTTOM OF BASIN (FT)	212.5	221	213
EMERGENCY SPILL WAY ELEV (FT)	219	229	220
EMERGENCY SPILL WAY LENGTH (FT)	50	50	50
TOP OF BASIN (FT)	220	230	221
DRAINAGE AREA (AC)	4.54	1.61	2.32
CHANNEL PROTECTION ZONE ELEV (CPV) (FT)	215.40	224.75	216
CPV VOLUME REQUIRED (CF)	14,014	5,523	13,330
VOLUME PROVIDED AT INVERT OF ORIFICE (CF)	14,484	10,982	22,173
RISER ELEVATION (FT)	218	228	219
ORIFICE SIZE (IN)	6	6	6
FOREBAY BOTTOM	213	222	213
FOREBAY SPILLWAY ELEV	215.40	224.75	216
FORBAY BERM ELEV	216	225.50	217
FORBAY VOLUME (CF)	1739	1528	4413
10 YEAR STORM ELEV	218.06	226.20	218.91
10 YEAR STORM VOLUME	46,240	18,569	40,387
100 YEAR STORM ELEV	218.73	226.83	219.54
100 YEAR STORM VOLUME	69,348	27,575	59,061

RISER-BASIN 4A				
R I SER D I AMETER	24″ RCP			
BARREL DIAMETER	15″ CMP			
BARREL INVERT	215.25			
DAYLIGHT INVERT	215.00			

RISER-BASIN 4B			
RISER DIAMETER	24″ RCP		
BARREL DIAMETER	15″ CMP		
BARREL INVERT	224.50		
DAYLIGHT INVERT	224.00		

1 POST CONSTRUCTION STORMWATER BASIN 17-G-1501-D-11 N.T.S.


Rev #	Date:	Description	Drawn By:	Rev #	Date:	Description	Drawn By:
А	08 Oct 2018	ISSUED FOR PERMIT	JR				

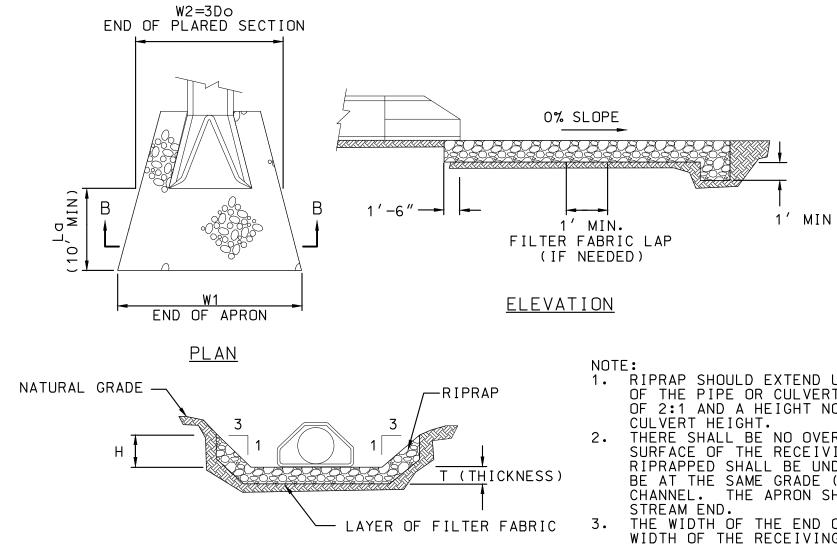

<u>SECTION B-B</u> NOTE: MINIMUM H=2/3 PIPE DIAMETER

OUTLET	Do (in)	La (ft)	W1=La+Do (f+)	W2=3Do (f+)	*D50 (in)	* T (in)	MINIMUM H (in)
1	15	10	12	3.75	6	18	16
2A	15	12	14	3.75	6	18	16
2B	12	12	14	3	6	18	16
20	12	10	12	3	6	18	16
3	12	10	12	3	6	18	16
4	15	10	12	3.75	6	18	16
5A	18	10	12	4.5	6	18	16
5B	12	10	12	3	6	18	16
6	24	14	16	6	6	18	16
7	15	10	12	3.75	6	18	16
8	24	14	16	6	6	18	16

17-G-1305-D-11/ N.T.S.

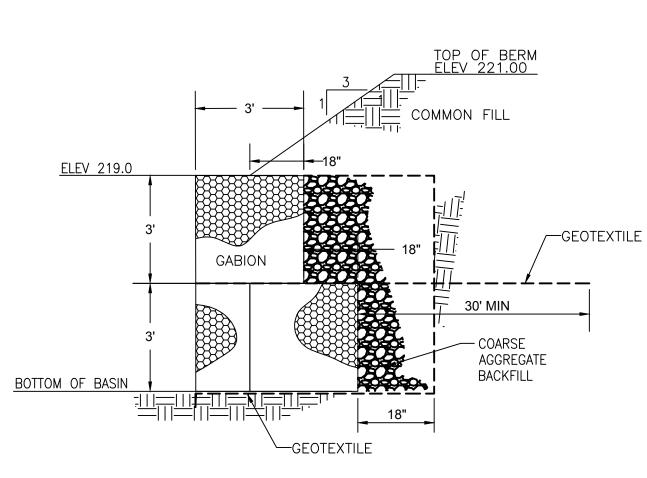



CONFIDENTIAL

MODIFIED EXISTING

BASIN 3D

205

213.25

50

214

6.55

210

26,271

36,789

212

6

²⁰⁸⁄209

212

213

1614 / 3825

212.51

53,968

213.23

91,096

24″ RCP

15″ CMP

216.00

215.90

RISER-BASIN 4B

RISER DIAMETER

BARREL DIAMETER

BARREL INVERT

DAYLIGHT INVERT

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REGENERON

Regeneron Pharmaceuticals, Inc. 81 Columbia Turnpike Rensselaer, NY 12144

Scale: AS NOTED

Bldg.:

NOTE	
1.	RIPRAP SHOULD EXTEND UP BOTH SIDES OF THE APRON AND AROUND THE END OF THE PIPE OR CULVERT AT THE DISCHARGE OUTLET AT A MAXIMUM SLOPE
	OF 2:1 AND A HEIGHT NOT LESS THAN TWO THIRDS OF THE PIPE DIAMETER OR
2.	CULVERT HEIGHT. THERE SHALL BE NO OVERFLOW FROM THE END OF THE APRON TO THE
۷ •	SURFACE OF THE RECEIVING CHANNEL. THE AREA TO BE PAVED OR
	RIPRAPPED SHALL BE UNDERCUT SO THAT THE INVERT OF THE APRON SHALL
	BE AT THE SAME GRADE (FLUSH) WITH THE SURFACE OF THE RECEIVING
	CHANNEL. THE APRON SHALL HAVE A CUTOFF OR TOE WALL AT THE DOWN
3.	STREAM END. THE WIDTH OF THE END OF THE APRON SHALL BE EQUAL TO THE BOTTOM
J.	WIDTH OF THE RECEIVING CHANNEL. MAXIMUM TAPER TO RECEIVING
	CHANNEL 5:1.
4.	THE PLACING OF FILL, EITHER LOOSE OR COMPACTED IN THE RECEIVING
_	CHANNEL SHALL NOT BE ALLOWED.
5.	NO BENDS OR CURVES IN THE HORIZONTAL ALIGNMENT OF THE APRON WILL
c	BE PERMITTED. FILTER FABRIC SHALL BE INSTALLED ON COMPACTED SUBGRADE PRIOR TO
6.	PLACEMENT OF RIPRAP.
7.	ANY DISTURBED AREA FROM END OF APRON TO RELIEVING CHANNEL MUST BE
	STABILIZED.



Planning Board—Town of East Greenbush BY DIRECTION OF CHAIRMAN OF THE PLANNING BOARD THESE PLANS ARE APPROVED SEE FIRST SHEET FOR DATE & SIGNATURE

SITE DETAILS		Drawing No. 17-G-1305-D-11	
		Old Drawing No.	
WG	Date: 28/8/2018	Revision: A	Sheet: