
MABEY'S REALTY — PHASE 2

STORAGE & COMMERCIAL BUILDING

486 3RD AVE EXTENSION, TOWN OF EAST GREENBUSH COUNTY OF RENSSELAER, STATE OF NEW YORK

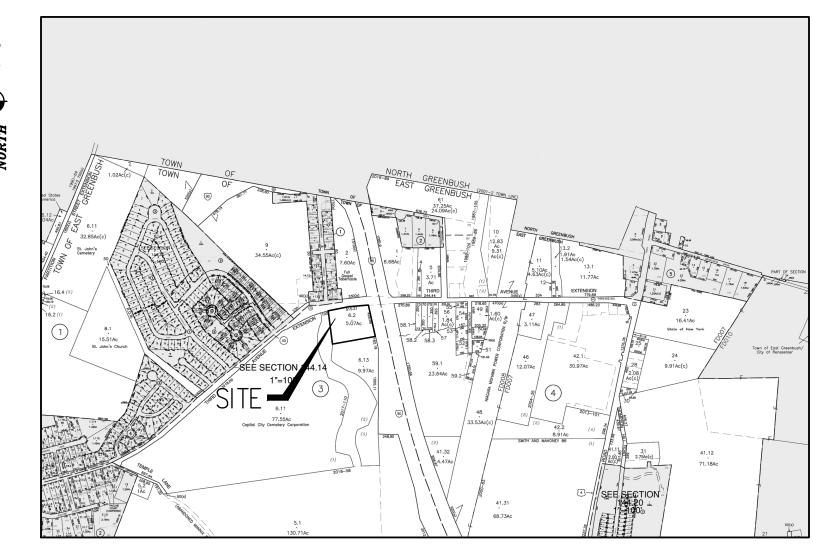

TAX MAP

AUGUST 3, 2022

REVISED: JANUARY 2023 MARCH 2023



C504

C505

C506

10

11

12

13

14

15

16

٨			, S	g.	S	S	
<u>A</u>	<u> </u>		REVD.	DAH	DAH	DAH	
	O SCALE		RE	۵	۵	۵	
	Sheet	List Table				/23	
	Sheet Title	Sheet Description				://2/2	
	C000	COVER SHEET			REVIEW	DATED	
	X100	EXISTING CONDITIONS		*			
	C100	SITE PLAN	Z O	REVIEW	VARY	LETTER	
	C110	GRADING & DRAINAGE PLAN	DESCRIPTION	FOR R	PRELIMINARY	I	
	C120	UTILITY PLAN	DESC	SSUED F		COMMENT	
	C130	EROSION CONTROL PLAN		ISSI	ED FOR	Ğ W	
	C140	LANDSCAPING PLAN			ISSUED	PER	
	C150	LIGHTING PLAN				REVISED	
	C403	BIORETENTION DETAILS-1				REV	
	C404	BIORETENTION DETAILS-2	Щ	/22	/5/23	/23	+
	C500	SITE DETAILS (1)	DATE	8/3/22	1/5/	3/21,	
	C501	SITE DETAILS (2)	NO.	-	2	23	
	C503	WATER DETAILS	Z				

PROJECT CONTACT LIST

GOVERNMENTAL APPROVAL AGENCIES

COUNTY HEALTH DEPARTMENT RENSSELAER COUNTY HEALTH DEPARTMENT 2ND FLOOR, NED PATTISON GOVERNMENT CENTER 1600 7TH AVENUE TROY, NY 12180

PLANNING BOARD

(518) 270-2655

TOWN OF EAST GREENBUSH DIRECTOR OF PLANNING: ANNA FELTHAM 225 COLUMBIA TURNPIKE RENSSELAER, NY 12144 EMAIL: AFELTHAM@EASTGREENBUSH.ORG

TELE (518) 694-4011 FAX (518) 477-2386

PUBLIC WORKS

TOWN OF EAST GREENBUSH PUBLIC WORKS DANIEL FIACCO (COMMISSIONER OF PUBLIC WORKS) DPW GARAGE

69 GILLIGAN ROAD EAST GREENBUSH, NY 12061-1710 DFIACCO@EASTGREENBUSH.ORG

477-6103 FAX: 477-5021 **UTILITY COMPANIES**

WATER & SEWER EAST GREENBUSH WATER SEWER DEPARTMENT 225 COLUMBIA TURNPIKE RENSSELAER, NY 12144

477-9367 CONTACT: MR. NICK MARINO (WATER) CONTACT: MR.GEORGE LOVELY (SEWER)

TELEPHONE VERIZON-NEW YORK 140 WEST STREET NEW YORK, NY 10007

GAS & ELECTRIC NATIONAL GRID 300 ERIE BOULEVARD WEST SYRACUSE, NY 13202-4250 642-4272

CABLE SPECTRUM CABLE 130 WASHINGTON AVENUE EXTENSION ALBANY, NY 12203 (518) 869-5500

TAX MAP INFORMATION:


TOWN OF EAST GREENBUSH SECTION 144.00, BLOCK 3, LOT 6.2

TOTAL PARCEL ACREAGE: 5.0 ACRES +/-

PREPARED FOR:

MABEY'S REALTY, INC. PO BOX 138 RENSSELAER, NY 12144 518-283-0017 ATTN: LAURA BLASS

PREPARED BY:

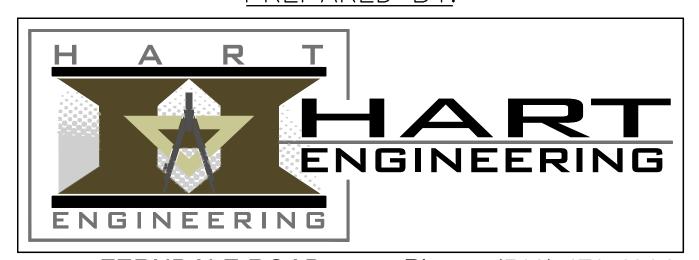

1969 FERNDALE ROAD CASTLETON NY, 12033 Phone: (518) 479-4014 Fax: (518) 477-6371

Dig Safely. New York Call Before You Dig
Wait The Required Time
Confirm Utility Response
Respect The Marks Dig With Care 800-962-7962

TOWN OF EAST GREENBUSH PLANNING BOARD

SANITARY DETAILS


STORM DETAILS (1)


EROSION CONTROL DETAILS

SITE PLAN APPROVAL BY PLANNING BOARD TOWN OF EAST GREENBUSH, NEW YORK CONDITIONS OR MODIFICATIONS

DATED		
APPROVED BY		
	CHAIRMAN	
DATED		
APPROVED BY		

COMMISSIONER OF PUBLIC WORKS

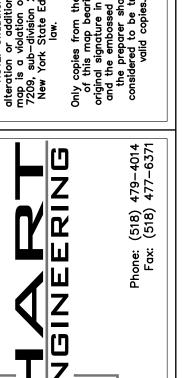

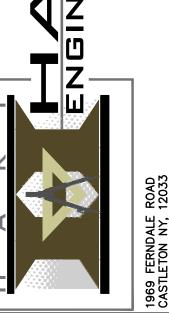





CK,D	SPH	SPH	SPH				
REVD.	DAH	DAH	DAH				
DESCRIPTION	ISSUED FOR REVIEW	ISSUED FOR PRELIMINARY REVIEW	REVISED PER MJ COMMENT LETTER DATED 2/27/23				
DATE	8/3/22	1/5/23	3/21/23				
NO.	-	2	3				
	DATE DESCRIPTION REVD.	DATE DESCRIPTION REVD. 8/3/22 ISSUED FOR REVIEW DAH	DATE DESCRIPTION REVD. 8/3/22 ISSUED FOR REVIEW DAH 1/5/23 ISSUED FOR PRELIMINARY REVIEW DAH	DATE DESCRIPTION REVD. 8/3/22 ISSUED FOR REVIEW DAH 1/5/23 ISSUED FOR PRELIMINARY REVIEW DAH 3/21/23 REVISED PER MJ COMMENT LETTER DATED 2/27/23 DAH	B/3/22 ISSUED FOR REVIEW DAH 1/5/23 ISSUED FOR PRELIMINARY REVIEW DAH 3/21/23 REVISED PER MJ COMMENT LETTER DATED 2/27/23 DAH	B/3/22 ISSUED FOR REVIEW DAH 1/5/23 ISSUED FOR PRELIMINARY REVIEW DAH 3/21/23 REVISED PER MJ COMMENT LETTER DATED 2/27/23 DAH	B/3/22 ISSUED FOR REVIEW DAH 1/5/23 ISSUED FOR PRELIMINARY REVIEW DAH 3/21/23 REVISED PER MJ COMMENT LETTER DATED 2/27/23 DAH

COVER SHEET MABEY'S REALTY STORAGE & COMMERCIAL BUILDINGS-PHASE 2	
---	--

ENGINEER:
STEVEN P. HART, P.E.
DRAWN BY:
DAH
DATE ISSUED:
AUGUST 2022
SCALE:
N.T.S.
DRAWING NUMBER:
C000
1 of 16

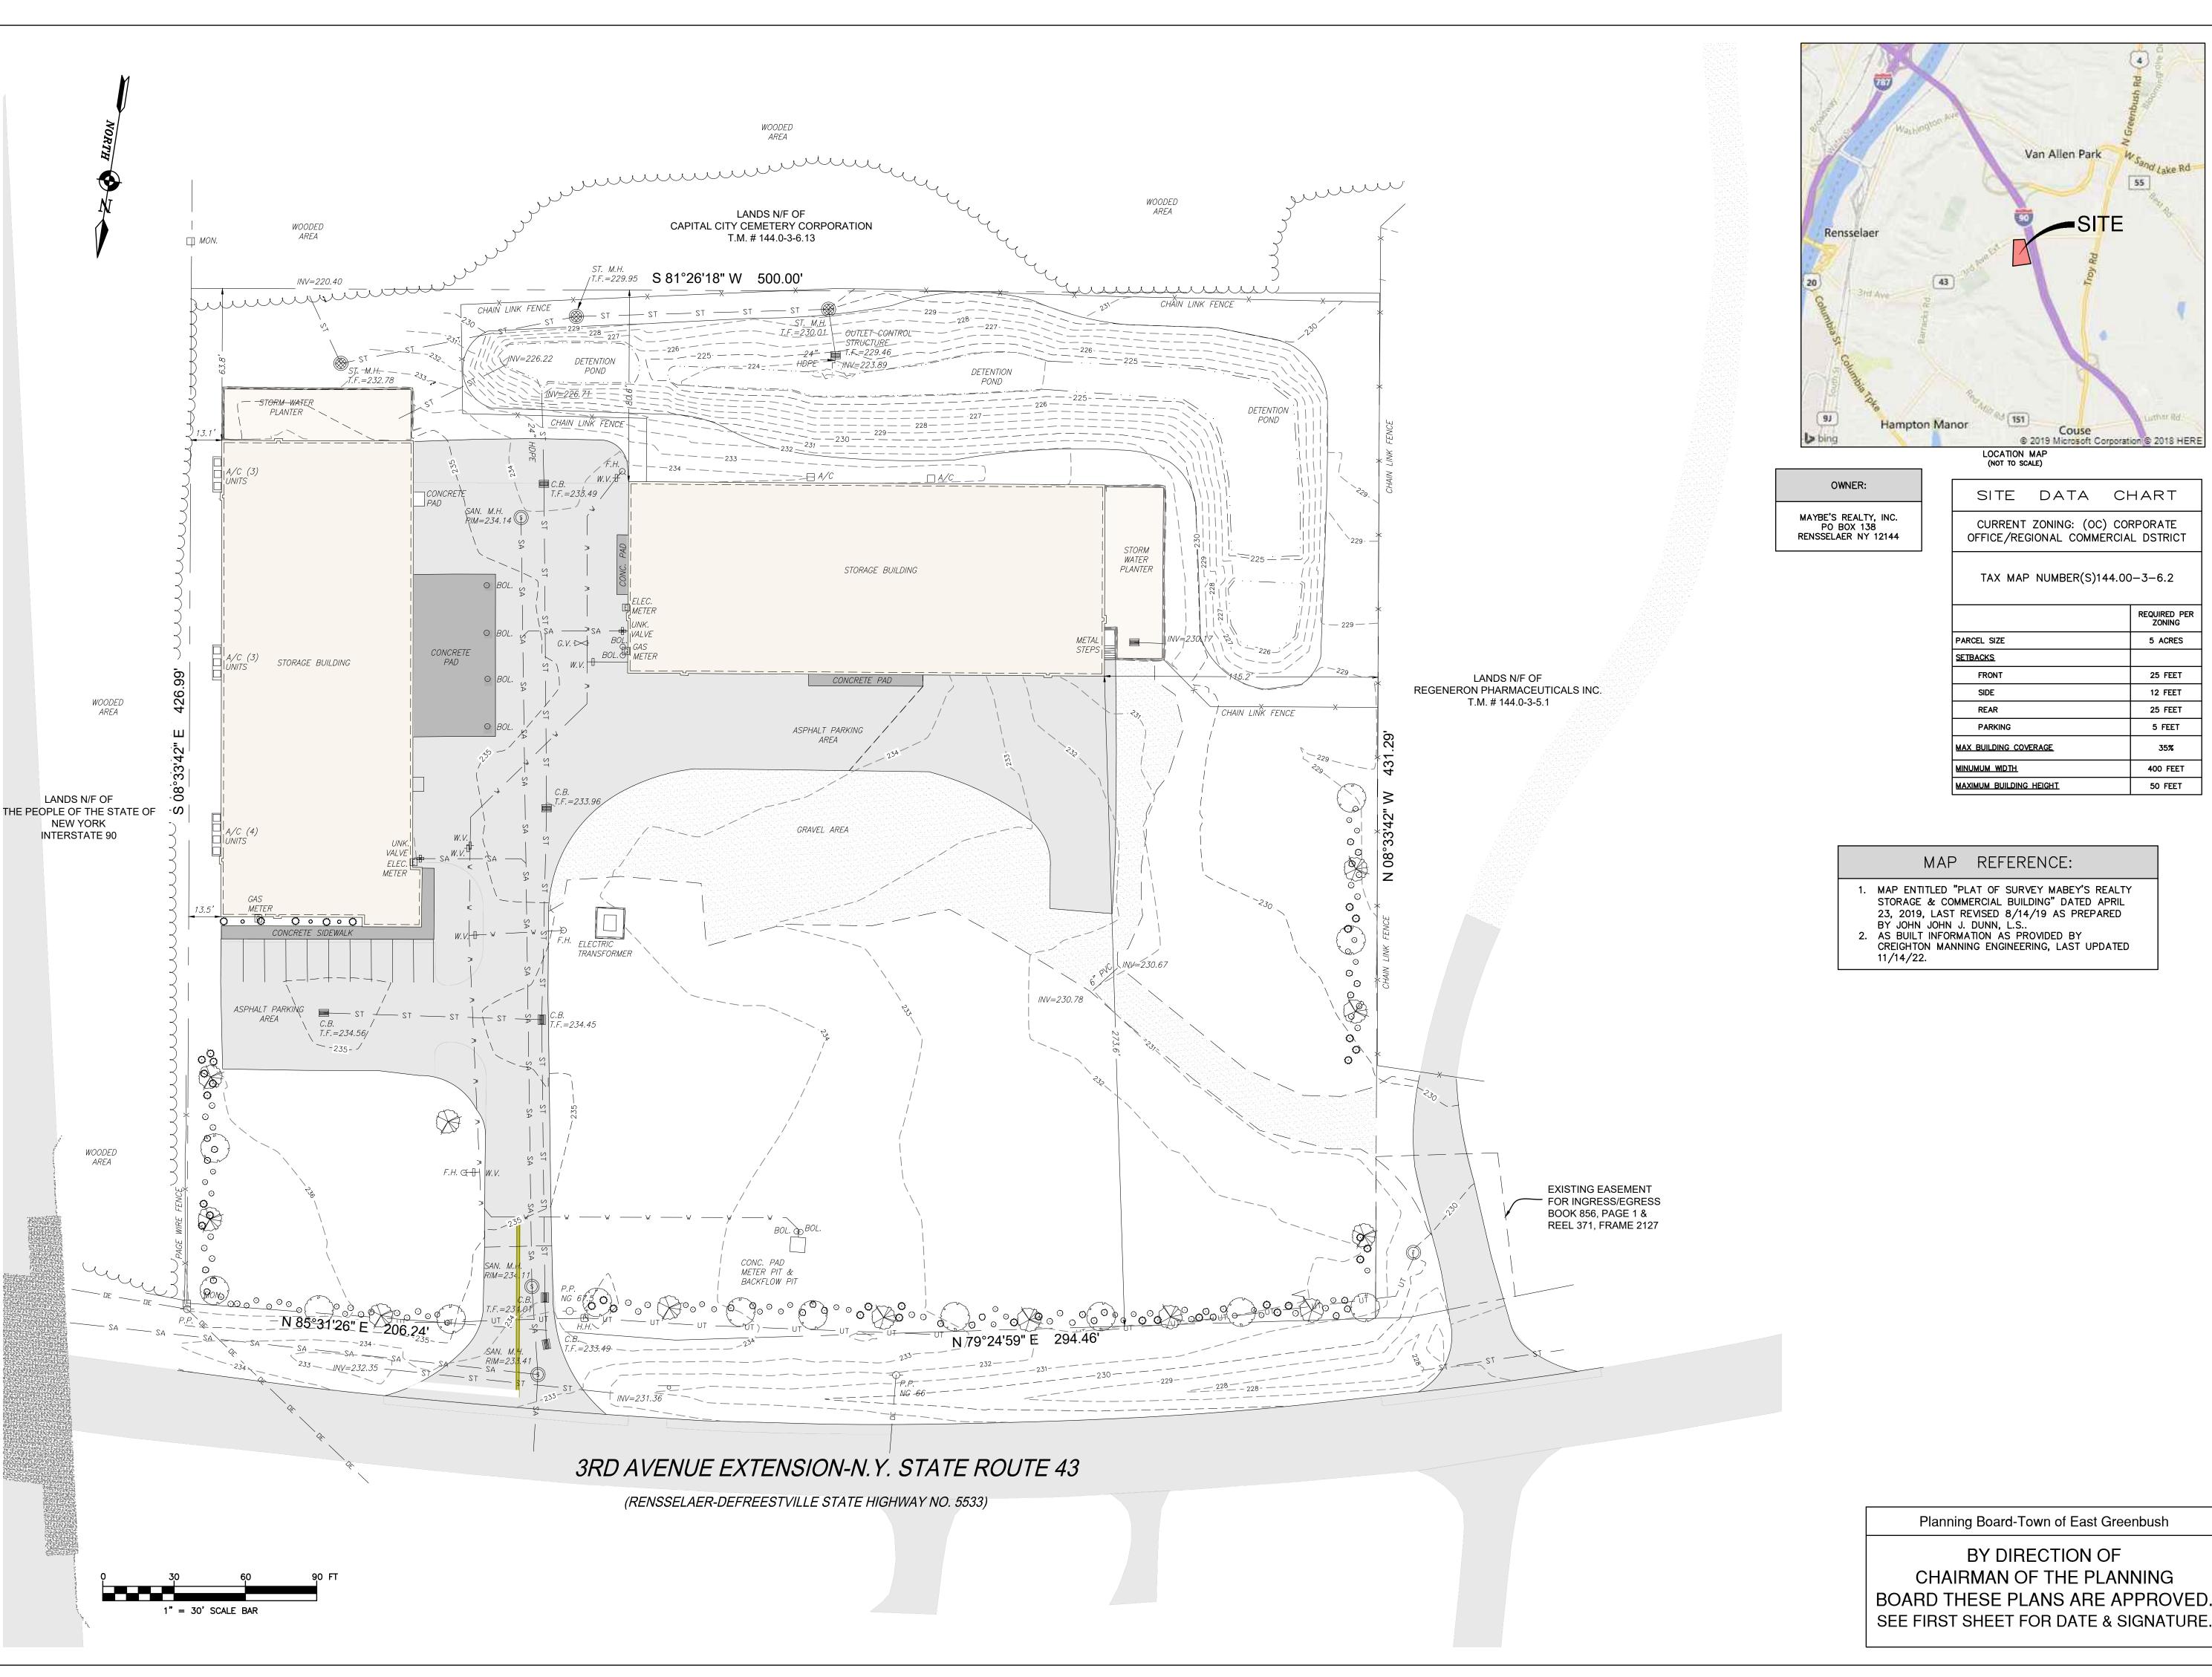

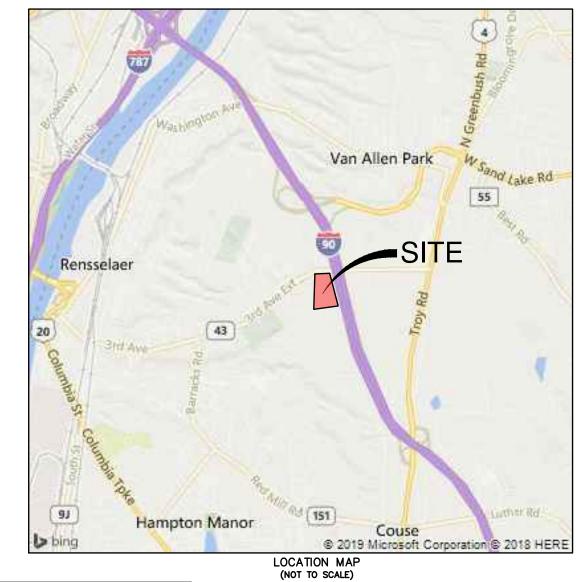

SITE DATA CHART CURRENT ZONING: (OC) CORPORATE

TAX MAP NUMBER(S)144.00-3-6.2

	REQUIRED PER ZONING
PARCEL SIZE	5 ACRES
<u>SETBACKS</u>	
FRONT	25 FEET
SIDE	12 FEET
REAR	25 FEET
PARKING	5 FEET
MAX BUILDING COVERAGE	35%
MINUMUM WIDTH	400 FEET
MAXIMUM BUILDING HEIGHT	50 FEET

MAP REFERENCE:

MAP ENTITLED "PLAT OF SURVEY MABEY'S REALTY STORAGE & COMMERCIAL BUILDING" DATED APRIL 23, 2019, LAST REVISED 8/14/19 AS PREPARED BY JOHN JOHN J. DUNN, L.S..
 AS BUILT INFORMATION AS PROVIDED BY CREIGHTON MANNING ENGINEERING, LAST UPDATED 11/14/22.


REVD. DAH DAH DAH

CONDITIONS EXISTING

ENGINEER:

DATE ISSUED: 1" = 30'

DRAWING NUMBER: X100

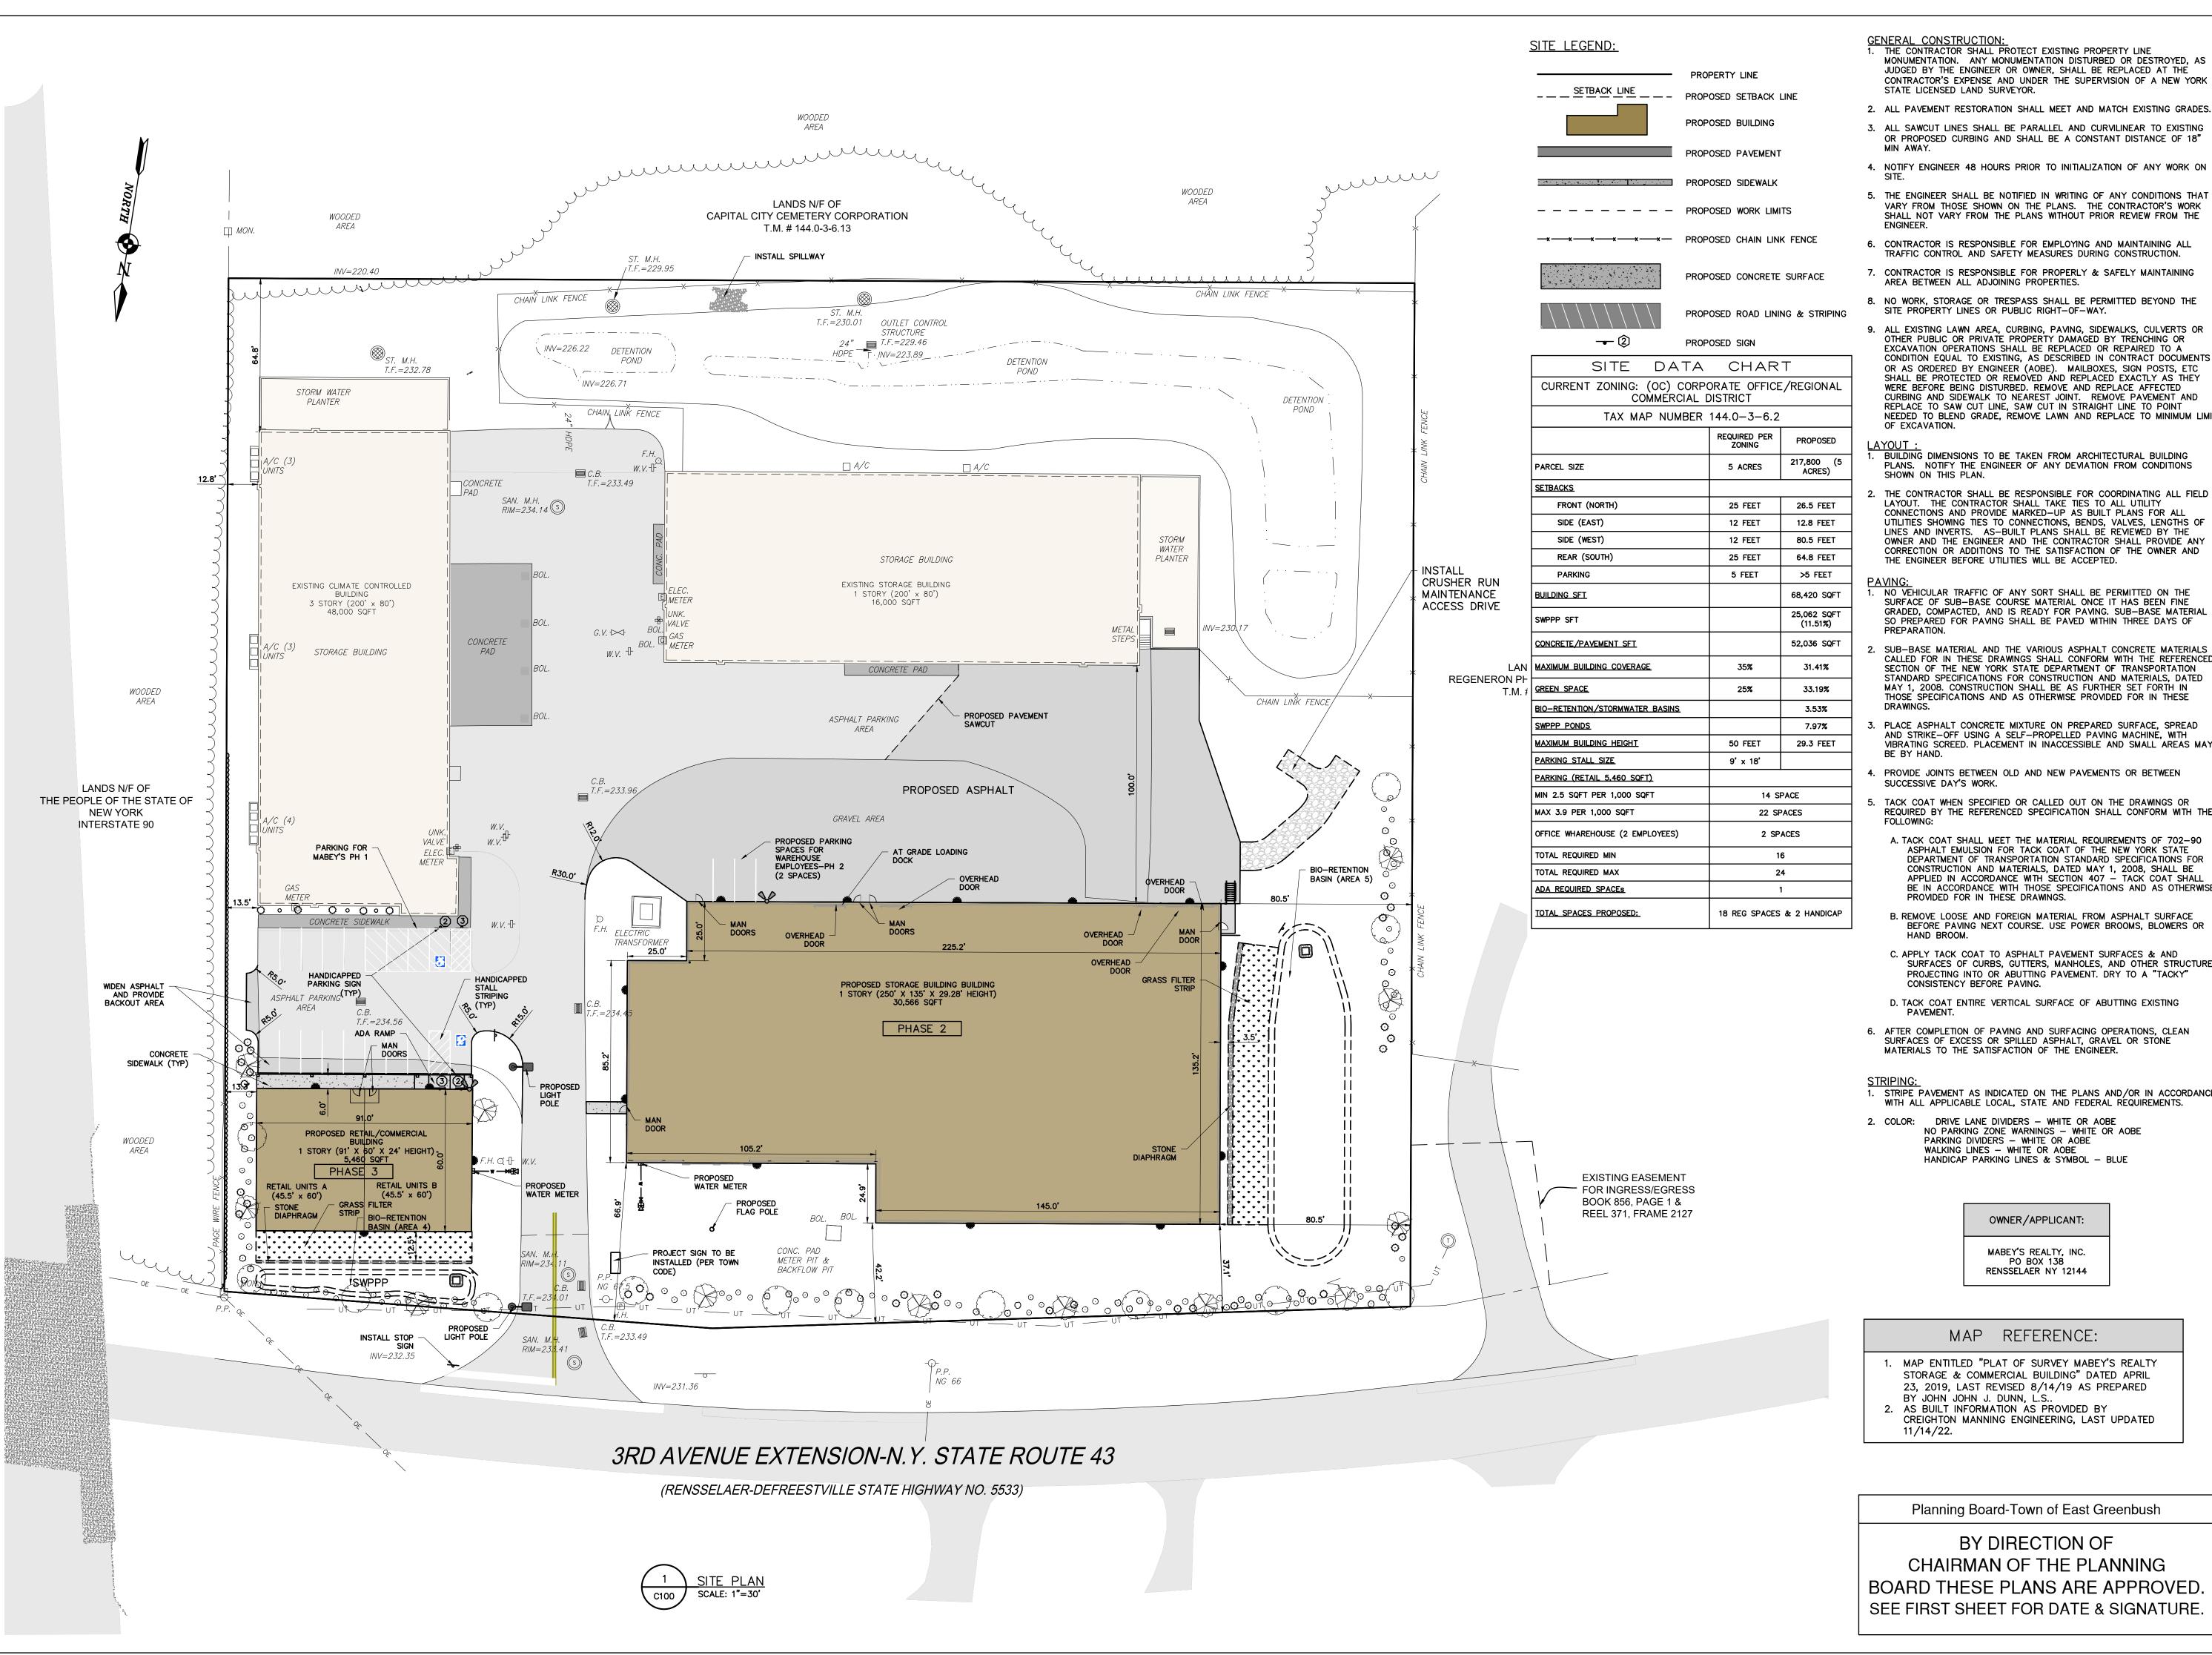

THE CONTRACTOR SHALL PROTECT EXISTING PROPERTY LINE MONUMENTATION. ANY MONUMENTATION DISTURBED OR DESTROYED, AS JUDGED BY THE ENGINEER OR OWNER, SHALL BE REPLACED AT THE CONTRACTOR'S EXPENSE AND UNDER THE SUPERVISION OF A NEW YORK

- 2. ALL PAVEMENT RESTORATION SHALL MEET AND MATCH EXISTING GRADES.
- 3. ALL SAWCUT LINES SHALL BE PARALLEL AND CURVILINEAR TO EXISTING OR PROPOSED CURBING AND SHALL BE A CONSTANT DISTANCE OF 18"
- 5. THE ENGINEER SHALL BE NOTIFIED IN WRITING OF ANY CONDITIONS THAT VARY FROM THOSE SHOWN ON THE PLANS. THE CONTRACTOR'S WORK
- CONTRACTOR IS RESPONSIBLE FOR PROPERLY & SAFELY MAINTAINING
- 8. NO WORK, STORAGE OR TRESPASS SHALL BE PERMITTED BEYOND THE
- 9. ALL EXISTING LAWN AREA, CURBING, PAVING, SIDEWALKS, CULVERTS OR OTHER PUBLIC OR PRIVATE PROPERTY DAMAGED BY TRENCHING OR EXCAVATION OPERATIONS SHALL BE REPLACED OR REPAIRED TO A CONDITION EQUAL TO EXISTING, AS DESCRIBED IN CONTRACT DOCUMENTS OR AS ORDERED BY ENGINEER (AOBE). MAILBOXES, SIGN POSTS, ETC SHALL BE PROTECTED OR REMOVED AND REPLACED EXACTLY AS THEY WERE BEFORE BEING DISTURBED. REMOVE AND REPLACE AFFECTED CURBING AND SIDEWALK TO NEAREST JOINT. REMOVE PAVEMENT AND REPLACE TO SAW CUT LINE, SAW CUT IN STRAIGHT LINE TO POINT NEEDED TO BLEND GRADE, REMOVE LAWN AND REPLACE TO MINIMUM LIMIT
- LAYOUT:

 1. BUILDING DIMENSIONS TO BE TAKEN FROM ARCHITECTURAL BUILDING

 1. BUILDING DIMENSIONS TO BE TAKEN FROM ARCHITECTURAL BUILDING

 1. BUILDING DIMENSIONS TO BE TAKEN FROM ARCHITECTURAL BUILDING TO BE TAKEN FROM CONDITIONS

 1. BUILDING DIMENSIONS TO BE TAKEN FROM ARCHITECTURAL BUILDING TO BUILDIN PLANS. NOTIFY THE ENGINEER OF ANY DEVIATION FROM CONDITIONS
- THE CONTRACTOR SHALL BE RESPONSIBLE FOR COORDINATING ALL FIELD LAYOUT. THE CONTRACTOR SHALL TAKE TIES TO ALL UTILITY CONNECTIONS AND PROVIDE MARKED-UP AS BUILT PLANS FOR ALL UTILITIES SHOWING TIES TO CONNECTIONS, BENDS, VALVES, LENGTHS OF LINES AND INVERTS. AS-BUILT PLANS SHALL BE REVIEWED BY THE OWNER AND THE ENGINEER AND THE CONTRACTOR SHALL PROVIDE ANY CORRECTION OR ADDITIONS TO THE SATISFACTION OF THE OWNER AND THE ENGINEER BEFORE UTILITIES WILL BE ACCEPTED.
- SURFACE OF SUB-BASE COURSE MATERIAL ONCE IT HAS BEEN FINE GRADED, COMPACTED, AND IS READY FOR PAVING. SUB-BASE MATERIAL SO PREPARED FOR PAVING SHALL BE PAVED WITHIN THREE DAYS OF
- CALLED FOR IN THESE DRAWINGS SHALL CONFORM WITH THE REFERENCED SECTION OF THE NEW YORK STATE DEPARTMENT OF TRANSPORTATION STANDARD SPECIFICATIONS FOR CONSTRUCTION AND MATERIALS, DATED MAY 1, 2008. CONSTRUCTION SHALL BE AS FURTHER SET FORTH IN THOSE SPECIFICATIONS AND AS OTHERWISE PROVIDED FOR IN THESE
- 3. PLACE ASPHALT CONCRETE MIXTURE ON PREPARED SURFACE, SPREAD AND STRIKE-OFF USING A SELF-PROPELLED PAVING MACHINE, WITH VIBRATING SCREED. PLACEMENT IN INACCESSIBLE AND SMALL AREAS MAY
- 4. PROVIDE JOINTS BETWEEN OLD AND NEW PAVEMENTS OR BETWEEN SUCCESSIVE DAY'S WORK.
- TACK COAT WHEN SPECIFIED OR CALLED OUT ON THE DRAWINGS OR REQUIRED BY THE REFERENCED SPECIFICATION SHALL CONFORM WITH THE
- ASPHALT EMULSION FOR TACK COAT OF THE NEW YORK STATE DEPARTMENT OF TRANSPORTATION STANDARD SPECIFICATIONS FOR APPLIED IN ACCORDANCE WITH SECTION 407 - TACK COAT SHALL BE IN ACCORDANCE WITH THOSE SPECIFICATIONS AND AS OTHERWISE PROVIDED FOR IN THESE DRAWINGS.
- B. REMOVE LOOSE AND FOREIGN MATERIAL FROM ASPHALT SURFACE BEFORE PAVING NEXT COURSE. USE POWER BROOMS, BLOWERS OR
- C. APPLY TACK COAT TO ASPHALT PAVEMENT SURFACES & AND SURFACES OF CURBS, GUTTERS, MANHOLES, AND OTHER STRUCTURES PROJECTING INTO OR ABUTTING PAVEMENT. DRY TO A "TACKY" CONSISTENCY BEFORE PAVING.
- D. TACK COAT ENTIRE VERTICAL SURFACE OF ABUTTING EXISTING
- 6. AFTER COMPLETION OF PAVING AND SURFACING OPERATIONS, CLEAN SURFACES OF EXCESS OR SPILLED ASPHALT, GRAVEL OR STONE MATERIALS TO THE SATISFACTION OF THE ENGINEER.

1. STRIPE PAVEMENT AS INDICATED ON THE PLANS AND/OR IN ACCORDANCE WITH ALL APPLICABLE LOCAL, STATE AND FEDERAL REQUIREMENTS.

2. COLOR: DRIVE LANE DIVIDERS — WHITE OR AOBE NO PARKING ZONE WARNINGS — WHITE OR AOBE PARKING DIVIDERS - WHITE OR AOBE WALKING LINES - WHITE OR AOBE HANDICAP PARKING LINES & SYMBOL - BLUE

OWNER/APPLICANT:

MABEY'S REALTY, INC. PO BOX 138 RENSSELAER NY 12144

MAP REFERENCE:

- MAP ENTITLED "PLAT OF SURVEY MABEY'S REALTY STORAGE & COMMERCIAL BUILDING" DATED APRIL 23, 2019, LAST REVISED 8/14/19 AS PREPARED BY JOHN JOHN J. DUNN, L.S..
- 2. AS BUILT INFORMATION AS PROVIDED BY CREIGHTON MANNING ENGINEERING, LAST UPDATED

Planning Board-Town of East Greenbush


BY DIRECTION OF CHAIRMAN OF THE PLANNING BOARD THESE PLANS ARE APPROVED SEE FIRST SHEET FOR DATE & SIGNATURE

PLAN S


ENGINEER: STEVEN P. HART, P.E. DRAWN BY:

DATE ISSUED: SCALE: 1" = 30'

DRAWING NUMBER:

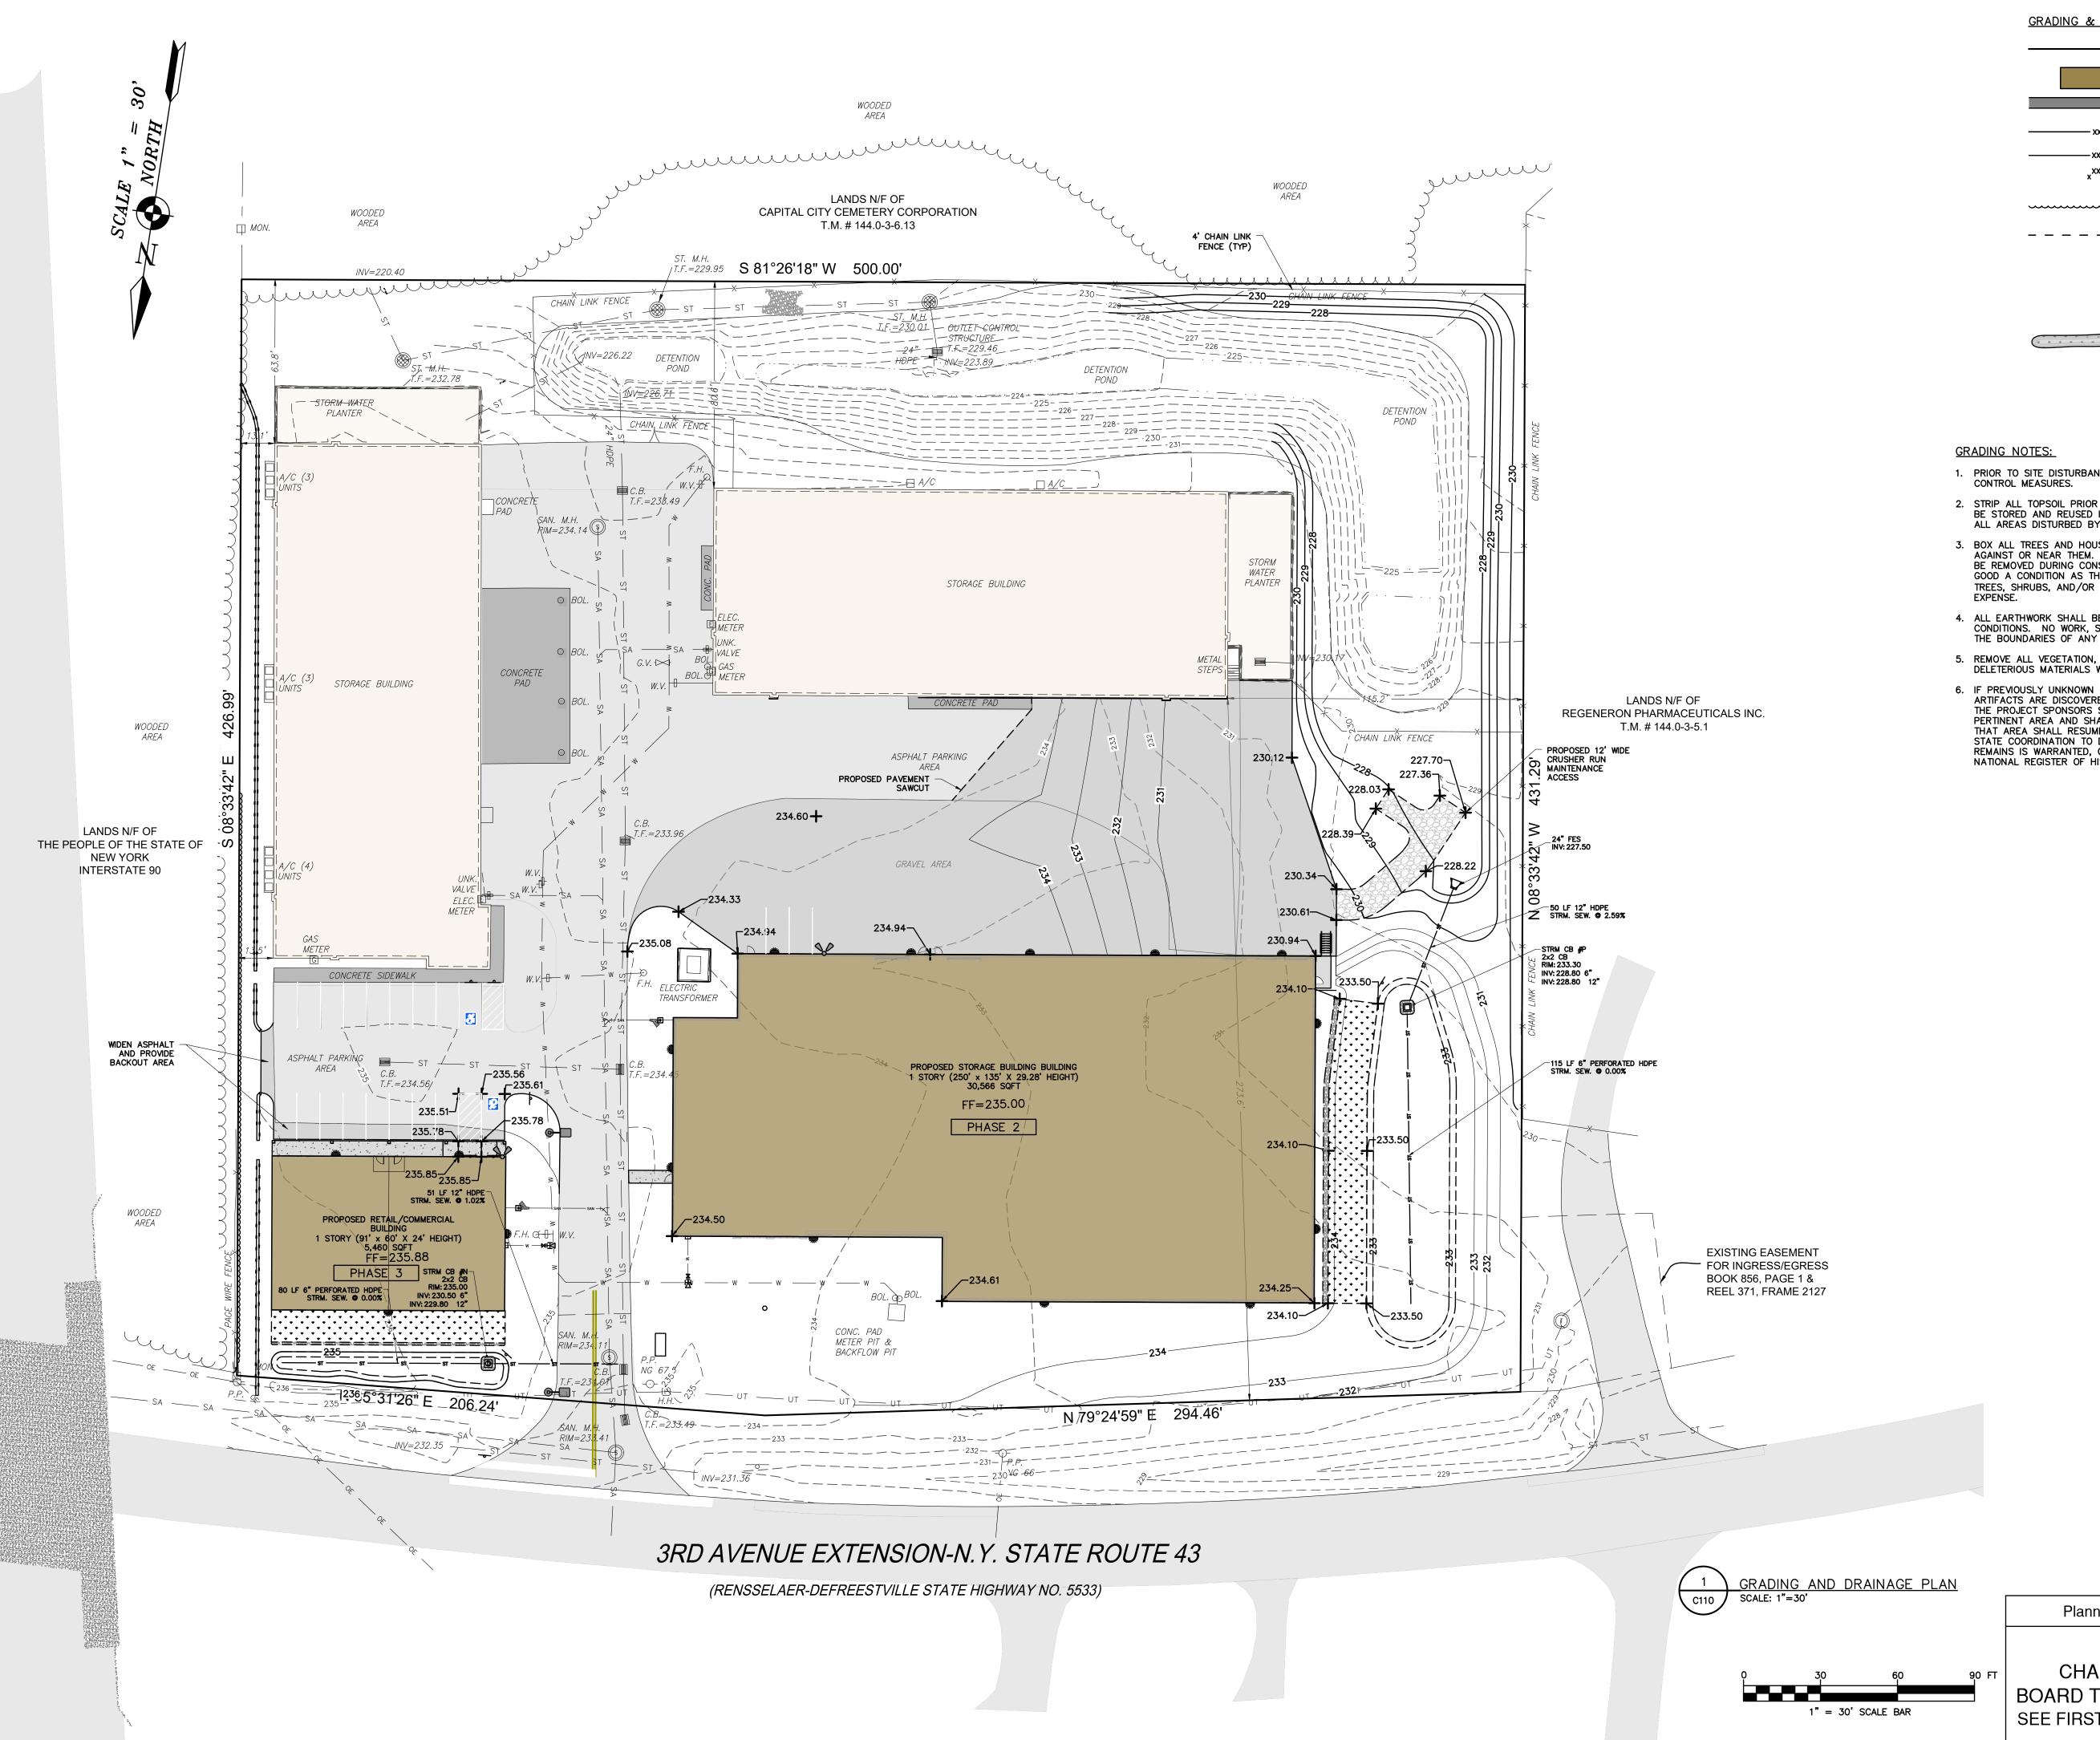

GRADING & DRAINAGE LEGEND:

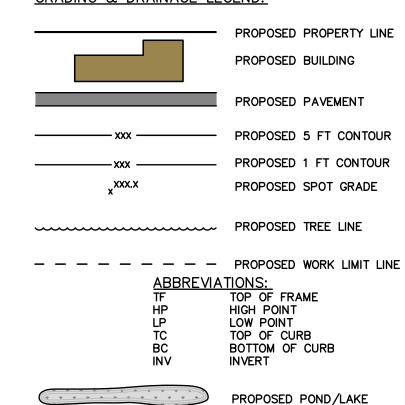

- PRIOR TO SITE DISTURBANCE, CONTRACTOR TO INSTALL EROSION & SEDIMENT CONTROL MEASURES.
- 2. STRIP ALL TOPSOIL PRIOR TO COMMENCING EARTHWORK OPERATIONS. TOPSOIL MAY BE STORED AND REUSED IN LAWN AND PLANTING AREAS ONLY. TOPSOIL AND SEED ALL AREAS DISTURBED BY CONSTRUCTION THAT ARE TO REMAIN GREEN.
- 3. BOX ALL TREES AND HOUSE ALL SHRUBS AND HEDGES BEFORE PLACING EARTH AGAINST OR NEAR THEM. ORNAMENTAL TREES, SHRUBS AND HEDGES WHICH MUST BE REMOVED DURING CONSTRUCTION SHALL BE HEALED IN AND RE-PLANTED IN AS GOOD A CONDITION AS THEY WERE BEFORE THEIR REMOVAL. ANY DAMAGED TREES, SHRUBS, AND/OR HEDGES SHALL BE REPLACED AT THE CONTRACTOR'S
- 4. ALL EARTHWORK SHALL BE SMOOTHLY AND EVENLY BLENDED INTO EXISTING CONDITIONS. NO WORK, STORAGE OR TRESPASS SHALL BE PERMITTED BEYOND THE BOUNDARIES OF ANY EASEMENT OR PROPERTY LINE.
- 5. REMOVE ALL VEGETATION, TREES, STUMPS, GRASSES, ORGANIC SOILS, DEBRIS AND DELETERIOUS MATERIALS WITHIN THE AREAS SLATED FOR CONSTRUCTION.
- 6. IF PREVIOUSLY UNKNOWN CULTURAL, ARCHEOLOGICAL, OR HISTORIC REMAINS OR ARTIFACTS ARE DISCOVERED IN THE COURSE OF CONSTRUCTION OF THIS PROJECT, THE PROJECT SPONSORS SHALL SUSPEND CONSTRUCTION OPERATIONS IN THE PERTINENT AREA AND SHALL NOTIFY THE PROJECT ENGINEER. CONSTRUCTION IN THAT AREA SHALL RESUME ONLY AFTER COMPLETION OF FEDERAL, TRIBAL, AND STATE COORDINATION TO DETERMINE WHETHER PROTECTION OR RECOVERY OF THE REMAINS IS WARRANTED, OR WHETHER THE SITE IS ELIGIBLE FOR LISTING IN THE NATIONAL REGISTER OF HISTORIC PLACES.

NOTE: Unauthorized alteration or addition to this map is a violation of section 7209, sub-division 2 of the New York State Education law.

Only copies from the original of this map bearing an original signature in red ink, and the embossed seal of the preparer shall be considered to be true and valid copies.


A R T

ENGINEERING

Phone: (518) 479-4014

NY, 12033

Phone: (518) 477-6371

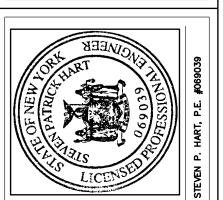

 NO.
 DATE
 DESCRIPTION
 REVD.
 CK¹

 1
 8/3/22
 ISSUED FOR REVIEW
 DAH
 SP¹

 2
 1/5/23
 ISSUED FOR PRELIMINARY REVIEW
 DAH
 SP¹

 3
 3/21/23
 REVISED PER MJ COMMENT LETTER DATED 2/27/23
 DAH
 SP¹

GRADING & DRAIN PLAN MABEY'S REALT

Dig Safely.
New York

Call Before You Dig
Wait The Required Time
Confirm Utility Response
Respect The Marks
Dig With Care
800-962-7962
www.digsafelynewyork.com

Planning Board-Town of East Greenbush

BY DIRECTION OF CHAIRMAN OF THE PLANNING BOARD THESE PLANS ARE APPROVED SEE FIRST SHEET FOR DATE & SIGNATURE ENGINEER:

STEVEN P. HART, P.E.

DRAWN BY:

DAH

DATE ISSUED:

DATE ISSUED:


AUGUST 2022

SCALE:

1" = 30'

DRAWING NUMBER:


C110 4 of 16

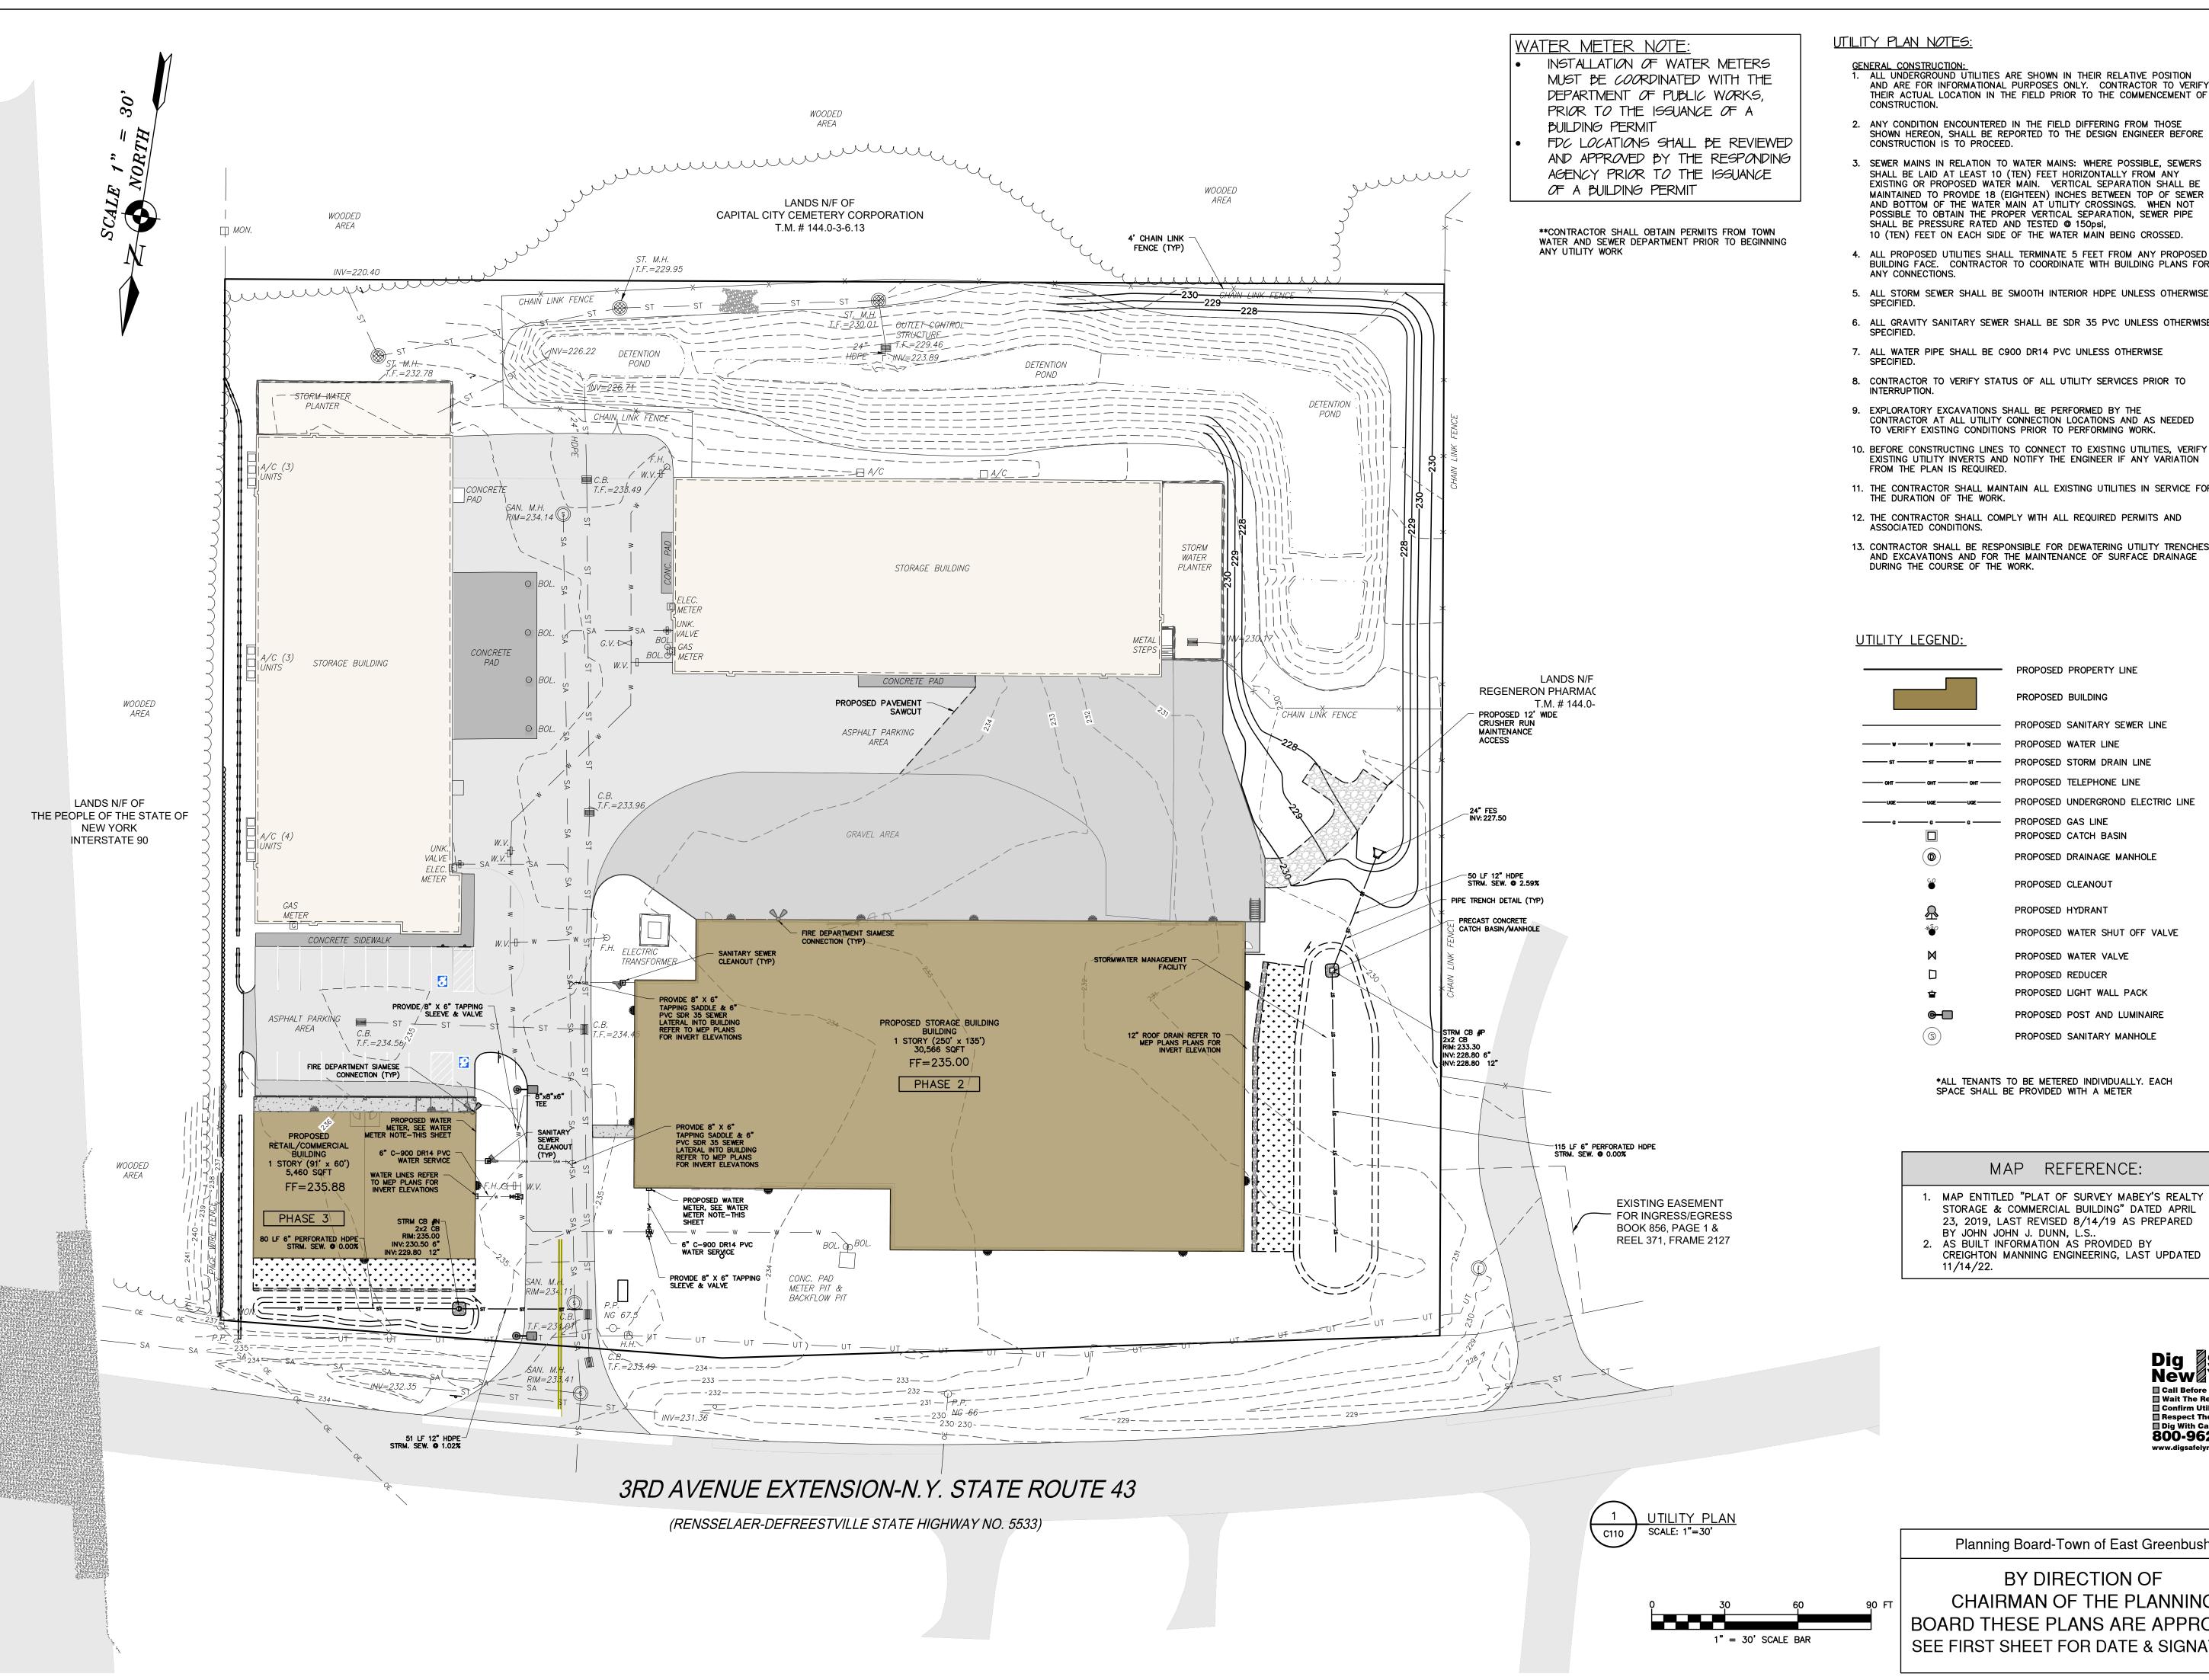

- GENERAL CONSTRUCTION:

 1. ALL UNDERGROUND UTILITIES ARE SHOWN IN THEIR RELATIVE POSITION AND ARE FOR INFORMATIONAL PURPOSES ONLY. CONTRACTOR TO VERIFY THEIR ACTUAL LOCATION IN THE FIELD PRIOR TO THE COMMENCEMENT OF
- 2. ANY CONDITION ENCOUNTERED IN THE FIELD DIFFERING FROM THOSE SHOWN HEREON, SHALL BE REPORTED TO THE DESIGN ENGINEER BEFORE CONSTRUCTION IS TO PROCEED.
- 3. SEWER MAINS IN RELATION TO WATER MAINS: WHERE POSSIBLE, SEWERS SHALL BE LAID AT LEAST 10 (TEN) FEET HORIZONTALLY FROM ANY EXISTING OR PROPOSED WATER MAIN. VERTICAL SEPARATION SHALL BE MAINTAINED TO PROVIDE 18 (EIGHTEEN) INCHES BETWEEN TOP OF SEWER AND BOTTOM OF THE WATER MAIN AT UTILITY CROSSINGS. WHEN NOT POSSIBLE TO OBTAIN THE PROPER VERTICAL SEPARATION, SEWER PIPE SHALL BE PRESSURE RATED AND TESTED @ 150psi, 10 (TEN) FEET ON EACH SIDE OF THE WATER MAIN BEING CROSSED.
- 4. ALL PROPOSED UTILITIES SHALL TERMINATE 5 FEET FROM ANY PROPOSED BUILDING FACE. CONTRACTOR TO COORDINATE WITH BUILDING PLANS FOR
- 5. ALL STORM SEWER SHALL BE SMOOTH INTERIOR HDPE UNLESS OTHERWISE
- 6. ALL GRAVITY SANITARY SEWER SHALL BE SDR 35 PVC UNLESS OTHERWISE

- CONTRACTOR AT ALL UTILITY CONNECTION LOCATIONS AND AS NEEDED TO VERIFY EXISTING CONDITIONS PRIOR TO PERFORMING WORK.
- 11. THE CONTRACTOR SHALL MAINTAIN ALL EXISTING UTILITIES IN SERVICE FOR
- 12. THE CONTRACTOR SHALL COMPLY WITH ALL REQUIRED PERMITS AND
- 13. CONTRACTOR SHALL BE RESPONSIBLE FOR DEWATERING UTILITY TRENCHES
- AND EXCAVATIONS AND FOR THE MAINTENANCE OF SURFACE DRAINAGE DURING THE COURSE OF THE WORK.

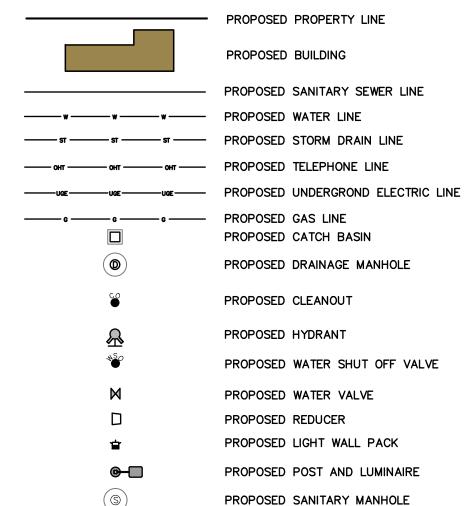

*ALL TENANTS TO BE METERED INDIVIDUALLY. EACH SPACE SHALL BE PROVIDED WITH A METER

MAP REFERENCE:

- 1. MAP ENTITLED "PLAT OF SURVEY MABEY'S REALTY STORAGE & COMMERCIAL BUILDING" DATED APRIL 23, 2019, LAST REVISED 8/14/19 AS PREPARED BY JOHN JOHN J. DUNN, L.S.. 2. AS BUILT INFORMATION AS PROVIDED BY
- CREIGHTON MANNING ENGINEERING, LAST UPDATED

Dig Safely. New York ☐ Call Before You Dig ☐ Wait The Required Time ☐ Confirm Utility Respons ☐ Respect The Marks Dig With Care 800-962-7962

Planning Board-Town of East Greenbush


BY DIRECTION OF CHAIRMAN OF THE PLANNING BOARD THESE PLANS ARE APPROVED SEE FIRST SHEET FOR DATE & SIGNATURE

UTILIT

ENGINEER: STEVEN P. HART, P.E.

DATE ISSUED: SCALE: 1" = 30'

DRAWING NUMBER: C120

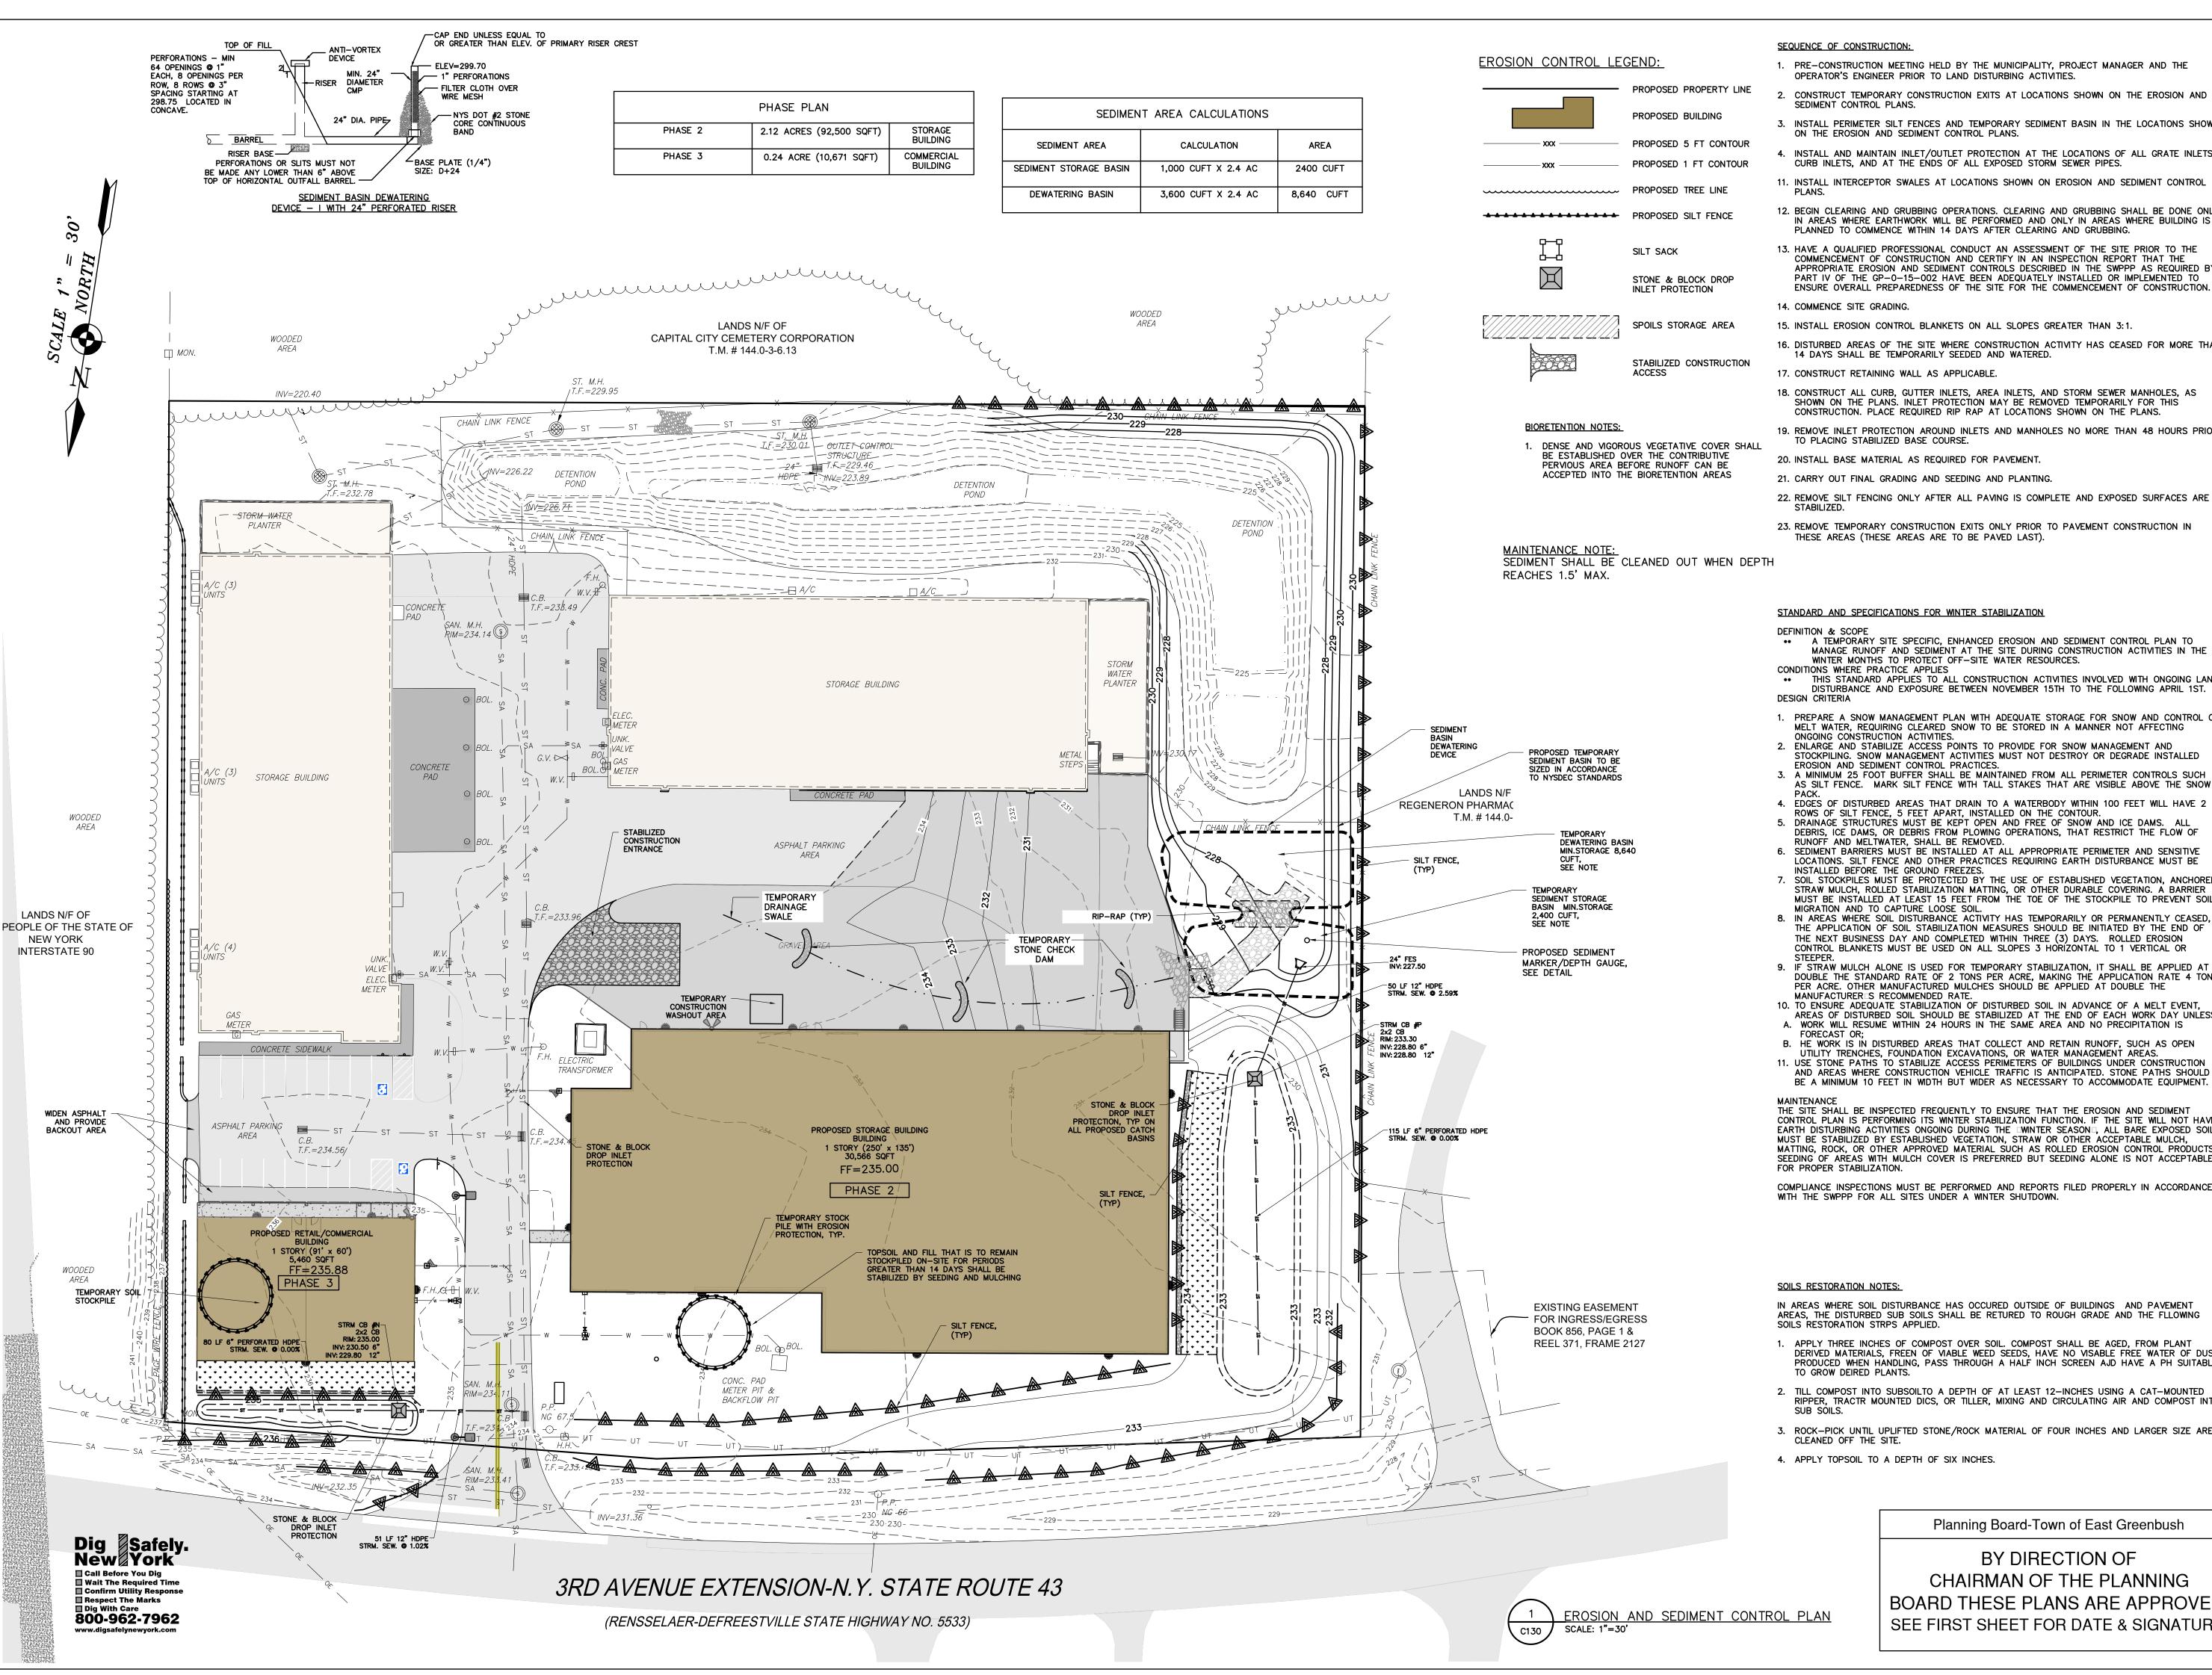

- 1. PRE-CONSTRUCTION MEETING HELD BY THE MUNICIPALITY, PROJECT MANAGER AND THE OPERATOR'S ENGINEER PRIOR TO LAND DISTURBING ACTIVITIES.
- 2. CONSTRUCT TEMPORARY CONSTRUCTION EXITS AT LOCATIONS SHOWN ON THE EROSION AND
- 3. INSTALL PERIMETER SILT FENCES AND TEMPORARY SEDIMENT BASIN IN THE LOCATIONS SHOWN ON THE EROSION AND SEDIMENT CONTROL PLANS.
- 4. INSTALL AND MAINTAIN INLET/OUTLET PROTECTION AT THE LOCATIONS OF ALL GRATE INLETS,
- 11. INSTALL INTERCEPTOR SWALES AT LOCATIONS SHOWN ON EROSION AND SEDIMENT CONTROL
- 12. BEGIN CLEARING AND GRUBBING OPERATIONS. CLEARING AND GRUBBING SHALL BE DONE ONLY IN AREAS WHERE EARTHWORK WILL BE PERFORMED AND ONLY IN AREAS WHERE BUILDING IS PLANNED TO COMMENCE WITHIN 14 DAYS AFTER CLEARING AND GRUBBING.
- 13. HAVE A QUALIFIED PROFESSIONAL CONDUCT AN ASSESSMENT OF THE SITE PRIOR TO THE COMMENCEMENT OF CONSTRUCTION AND CERTIFY IN AN INSPECTION REPORT THAT THE APPROPRIATE EROSION AND SEDIMENT CONTROLS DESCRIBED IN THE SWPPP AS REQUIRED BY PART IV OF THE GP-0-15-002 HAVE BEEN ADEQUATELY INSTALLED OR IMPLEMENTED TO
- 15. INSTALL EROSION CONTROL BLANKETS ON ALL SLOPES GREATER THAN 3:1.
- 16. DISTURBED AREAS OF THE SITE WHERE CONSTRUCTION ACTIVITY HAS CEASED FOR MORE THAN 14 DAYS SHALL BE TEMPORARILY SEEDED AND WATERED.
- 17. CONSTRUCT RETAINING WALL AS APPLICABLE.
- 18. CONSTRUCT ALL CURB, GUTTER INLETS, AREA INLETS, AND STORM SEWER MANHOLES, AS SHOWN ON THE PLANS. INLET PROTECTION MAY BE REMOVED TEMPORARILY FOR THIS CONSTRUCTION. PLACE REQUIRED RIP RAP AT LOCATIONS SHOWN ON THE PLANS.
- 19. REMOVE INLET PROTECTION AROUND INLETS AND MANHOLES NO MORE THAN 48 HOURS PRIOR
- 20. INSTALL BASE MATERIAL AS REQUIRED FOR PAVEMENT.
- 21. CARRY OUT FINAL GRADING AND SEEDING AND PLANTING.
- 22. REMOVE SILT FENCING ONLY AFTER ALL PAVING IS COMPLETE AND EXPOSED SURFACES ARE
- 23. REMOVE TEMPORARY CONSTRUCTION EXITS ONLY PRIOR TO PAVEMENT CONSTRUCTION IN THESE AREAS (THESE AREAS ARE TO BE PAVED LAST).

STANDARD AND SPECIFICATIONS FOR WINTER STABILIZATION

•• A TEMPORARY SITE SPECIFIC, ENHANCED EROSION AND SEDIMENT CONTROL PLAN TO MANAGE RUNOFF AND SEDIMENT AT THE SITE DURING CONSTRUCTION ACTIVITIES IN THE WINTER MONTHS TO PROTECT OFF-SITE WATER RESOURCES.

THIS STANDARD APPLIES TO ALL CONSTRUCTION ACTIVITIES INVOLVED WITH ONGOING LAND DISTURBANCE AND EXPOSURE BETWEEN NOVEMBER 15TH TO THE FOLLOWING APRIL 1ST.

- 1. PREPARE A SNOW MANAGEMENT PLAN WITH ADEQUATE STORAGE FOR SNOW AND CONTROL OF MELT WATER, REQUIRING CLEARED SNOW TO BE STORED IN A MANNER NOT AFFECTING
- 2. ENLARGE AND STABILIZE ACCESS POINTS TO PROVIDE FOR SNOW MANAGEMENT AND STOCKPILING. SNOW MANAGEMENT ACTIVITIES MUST NOT DESTROY OR DEGRADE INSTALLED
- 3. A MINIMUM 25 FOOT BUFFER SHALL BE MAINTAINED FROM ALL PERIMETER CONTROLS SUCH AS SILT FENCE. MARK SILT FENCE WITH TALL STAKES THAT ARE VISIBLE ABOVE THE SNOW
- 4. EDGES OF DISTURBED AREAS THAT DRAIN TO A WATERBODY WITHIN 100 FEET WILL HAVE 2.
- ROWS OF SILT FENCE, 5 FEET APART, INSTALLED ON THE CONTOUR. 5. DRAINAGE STRUCTURES MUST BE KEPT OPEN AND FREE OF SNOW AND ICE DAMS. ALL
- DEBRIS, ICE DAMS, OR DEBRIS FROM PLOWING OPERATIONS, THAT RESTRICT THE FLOW OF RUNOFF AND MELTWATER, SHALL BE REMOVED. 6. SEDIMENT BARRIERS MUST BE INSTALLED AT ALL APPROPRIATE PERIMETER AND SENSITIVE
- LOCATIONS. SILT FENCE AND OTHER PRACTICES REQUIRING EARTH DISTURBANCE MUST BE INSTALLED BEFORE THE GROUND FREEZES.
- SOIL STOCKPILES MUST BE PROTECTED BY THE USE OF ESTABLISHED VEGETATION, ANCHORED STRAW MULCH, ROLLED STABILIZATION MATTING, OR OTHER DURABLE COVERING. A BARRIER MUST BE INSTALLED AT LEAST 15 FEET FROM THE TOE OF THE STOCKPILE TO PREVENT SOIL
- 8. IN AREAS WHERE SOIL DISTURBANCE ACTIVITY HAS TEMPORARILY OR PERMANENTLY CEASED, THE APPLICATION OF SOIL STABILIZATION MEASURES SHOULD BE INITIATED BY THE END OF THE NEXT BUSINESS DAY AND COMPLETED WITHIN THREE (3) DAYS. ROLLED EROSION CONTROL BLANKETS MUST BE USED ON ALL SLOPES 3 HORIZONTAL TO 1 VERTICAL OR
- 9. IF STRAW MULCH ALONE IS USED FOR TEMPORARY STABILIZATION, IT SHALL BE APPLIED AT DOUBLE THE STANDARD RATE OF 2 TONS PER ACRE, MAKING THE APPLICATION RATE 4 TONS PER ACRE. OTHER MANUFACTURED MULCHES SHOULD BE APPLIED AT DOUBLE THE
- MANUFACTURER S RECOMMENDED RATE. 10. TO ENSURE ADEQUATE STABILIZATION OF DISTURBED SOIL IN ADVANCE OF A MELT EVENT, AREAS OF DISTURBED SOIL SHOULD BE STABILIZED AT THE END OF EACH WORK DAY UNLESS:
- A. WORK WILL RESUME WITHIN 24 HOURS IN THE SAME AREA AND NO PRECIPITATION IS B. HE WORK IS IN DISTURBED AREAS THAT COLLECT AND RETAIN RUNOFF, SUCH AS OPEN
- UTILITY TRENCHES, FOUNDATION EXCAVATIONS, OR WATER MANAGEMENT AREAS. 11. USE STONE PATHS TO STABILIZE ACCESS PERIMETERS OF BUILDINGS UNDER CONSTRUCTION AND AREAS WHERE CONSTRUCTION VEHICLE TRAFFIC IS ANTICIPATED. STONE PATHS SHOULD BE A MINIMUM 10 FEET IN WIDTH BUT WIDER AS NECESSARY TO ACCOMMODATE EQUIPMENT.

THE SITE SHALL BE INSPECTED FREQUENTLY TO ENSURE THAT THE EROSION AND SEDIMENT CONTROL PLAN IS PERFORMING ITS WINTER STABILIZATION FUNCTION. IF THE SITE WILL NOT HAVE EARTH DISTURBING ACTIVITIES ONGOING DURING THE DWINTER SEASON, ALL BARE EXPOSED SOIL MUST BE STABILIZED BY ESTABLISHED VEGETATION, STRAW OR OTHER ACCEPTABLE MULCH, MATTING, ROCK, OR OTHER APPROVED MATERIAL SUCH AS ROLLED EROSION CONTROL PRODUCTS SEEDING OF AREAS WITH MULCH COVER IS PREFERRED BUT SEEDING ALONE IS NOT ACCEPTABLE


COMPLIANCE INSPECTIONS MUST BE PERFORMED AND REPORTS FILED PROPERLY IN ACCORDANCE

IN AREAS WHERE SOIL DISTURBANCE HAS OCCURED OUTSIDE OF BUILDINGS AND PAVEMENT AREAS, THE DISTURBED SUB SOILS SHALL BE RETURED TO ROUGH GRADE AND THE FLLOWING

- 1. APPLY THREE INCHES OF COMPOST OVER SOIL. COMPOST SHALL BE AGED, FROM PLANT DERIVED MATERIALS, FREEN OF VIABLE WEED SEEDS, HAVE NO VISABLE FREE WATER OF DUST PRODUCED WHEN HANDLING, PASS THROUGH A HALF INCH SCREEN AJD HAVE A PH SUITABLE
- 2. TILL COMPOST INTO SUBSOILTO A DEPTH OF AT LEAST 12-INCHES USING A CAT-MOUNTED RIPPER, TRACTR MOUNTED DICS, OR TILLER, MIXING AND CIRCULATING AIR AND COMPOST INTO
- 3. ROCK-PICK UNTIL UPLIFTED STONE/ROCK MATERIAL OF FOUR INCHES AND LARGER SIZE ARE CLEANED OFF THE SITE.
- 4. APPLY TOPSOIL TO A DEPTH OF SIX INCHES.

Planning Board-Town of East Greenbush

BY DIRECTION OF CHAIRMAN OF THE PLANNING BOARD THESE PLANS ARE APPROVED SEE FIRST SHEET FOR DATE & SIGNATURE

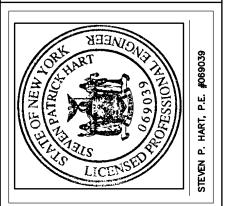



X


TROL . NO SION \circ \bigcirc


ENGINEER: STEVEN P. HART, P.E DRAWN BY:


DATE ISSUED: SCALE: DRAWING NUMBER:

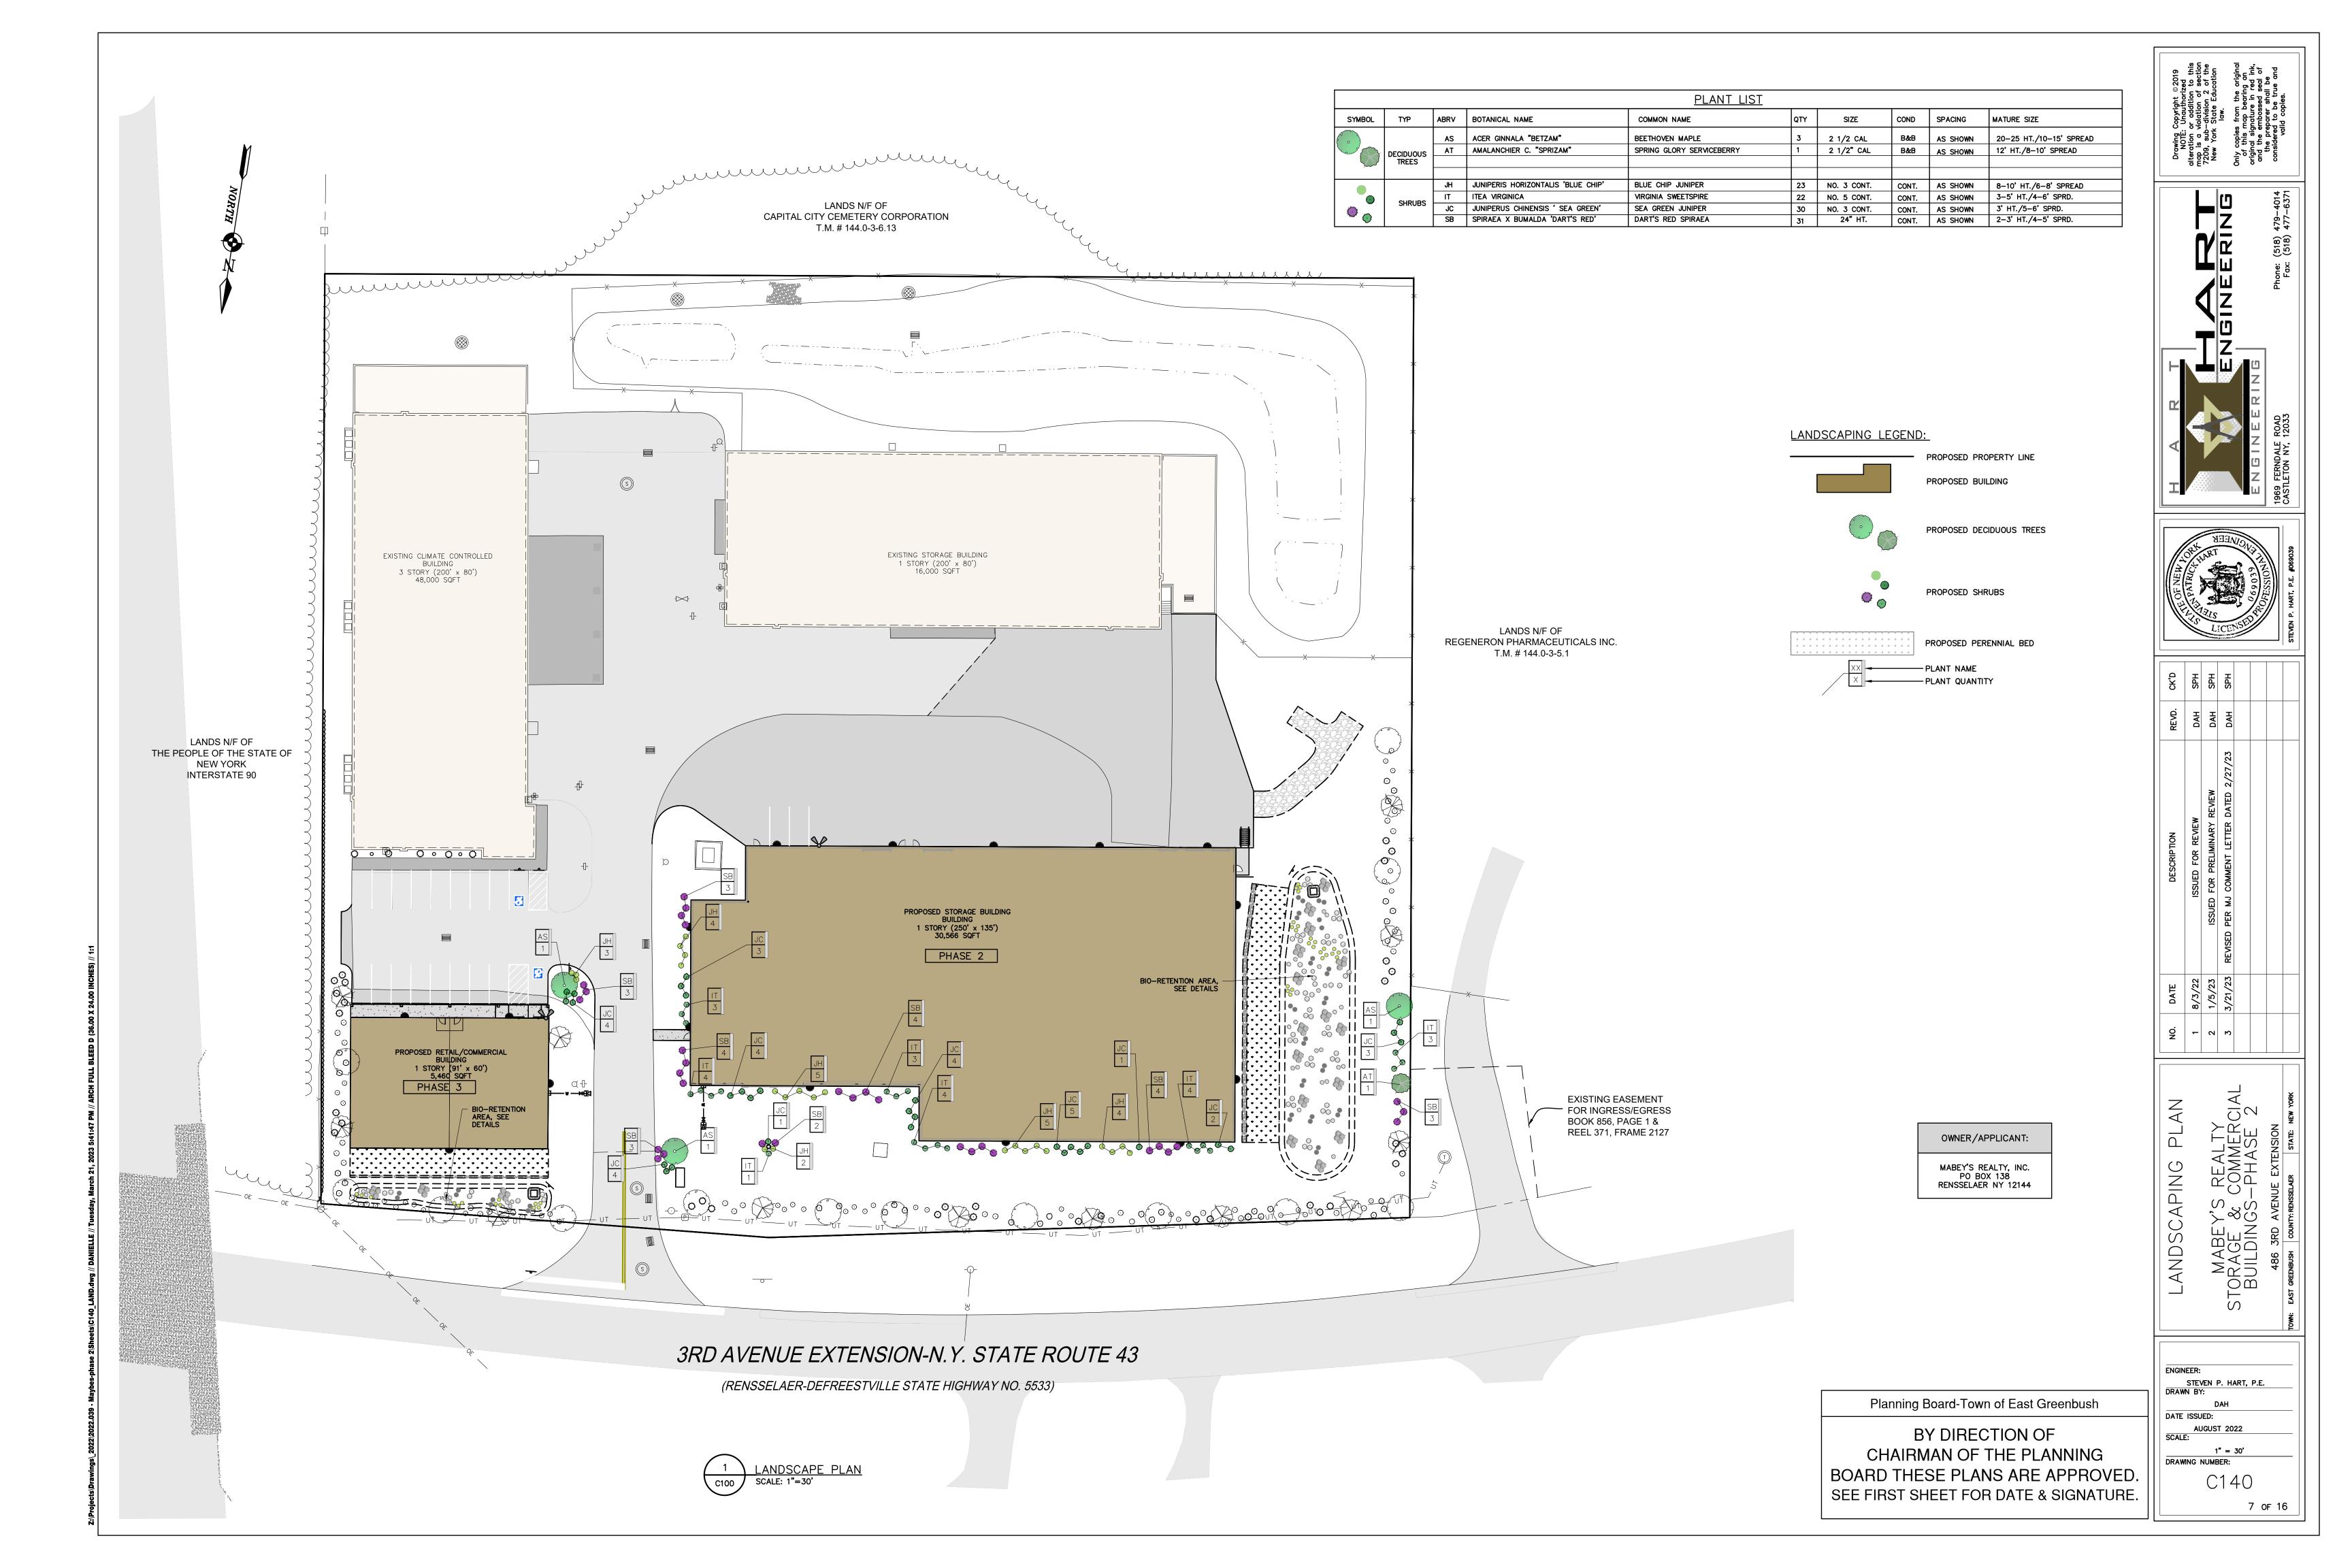

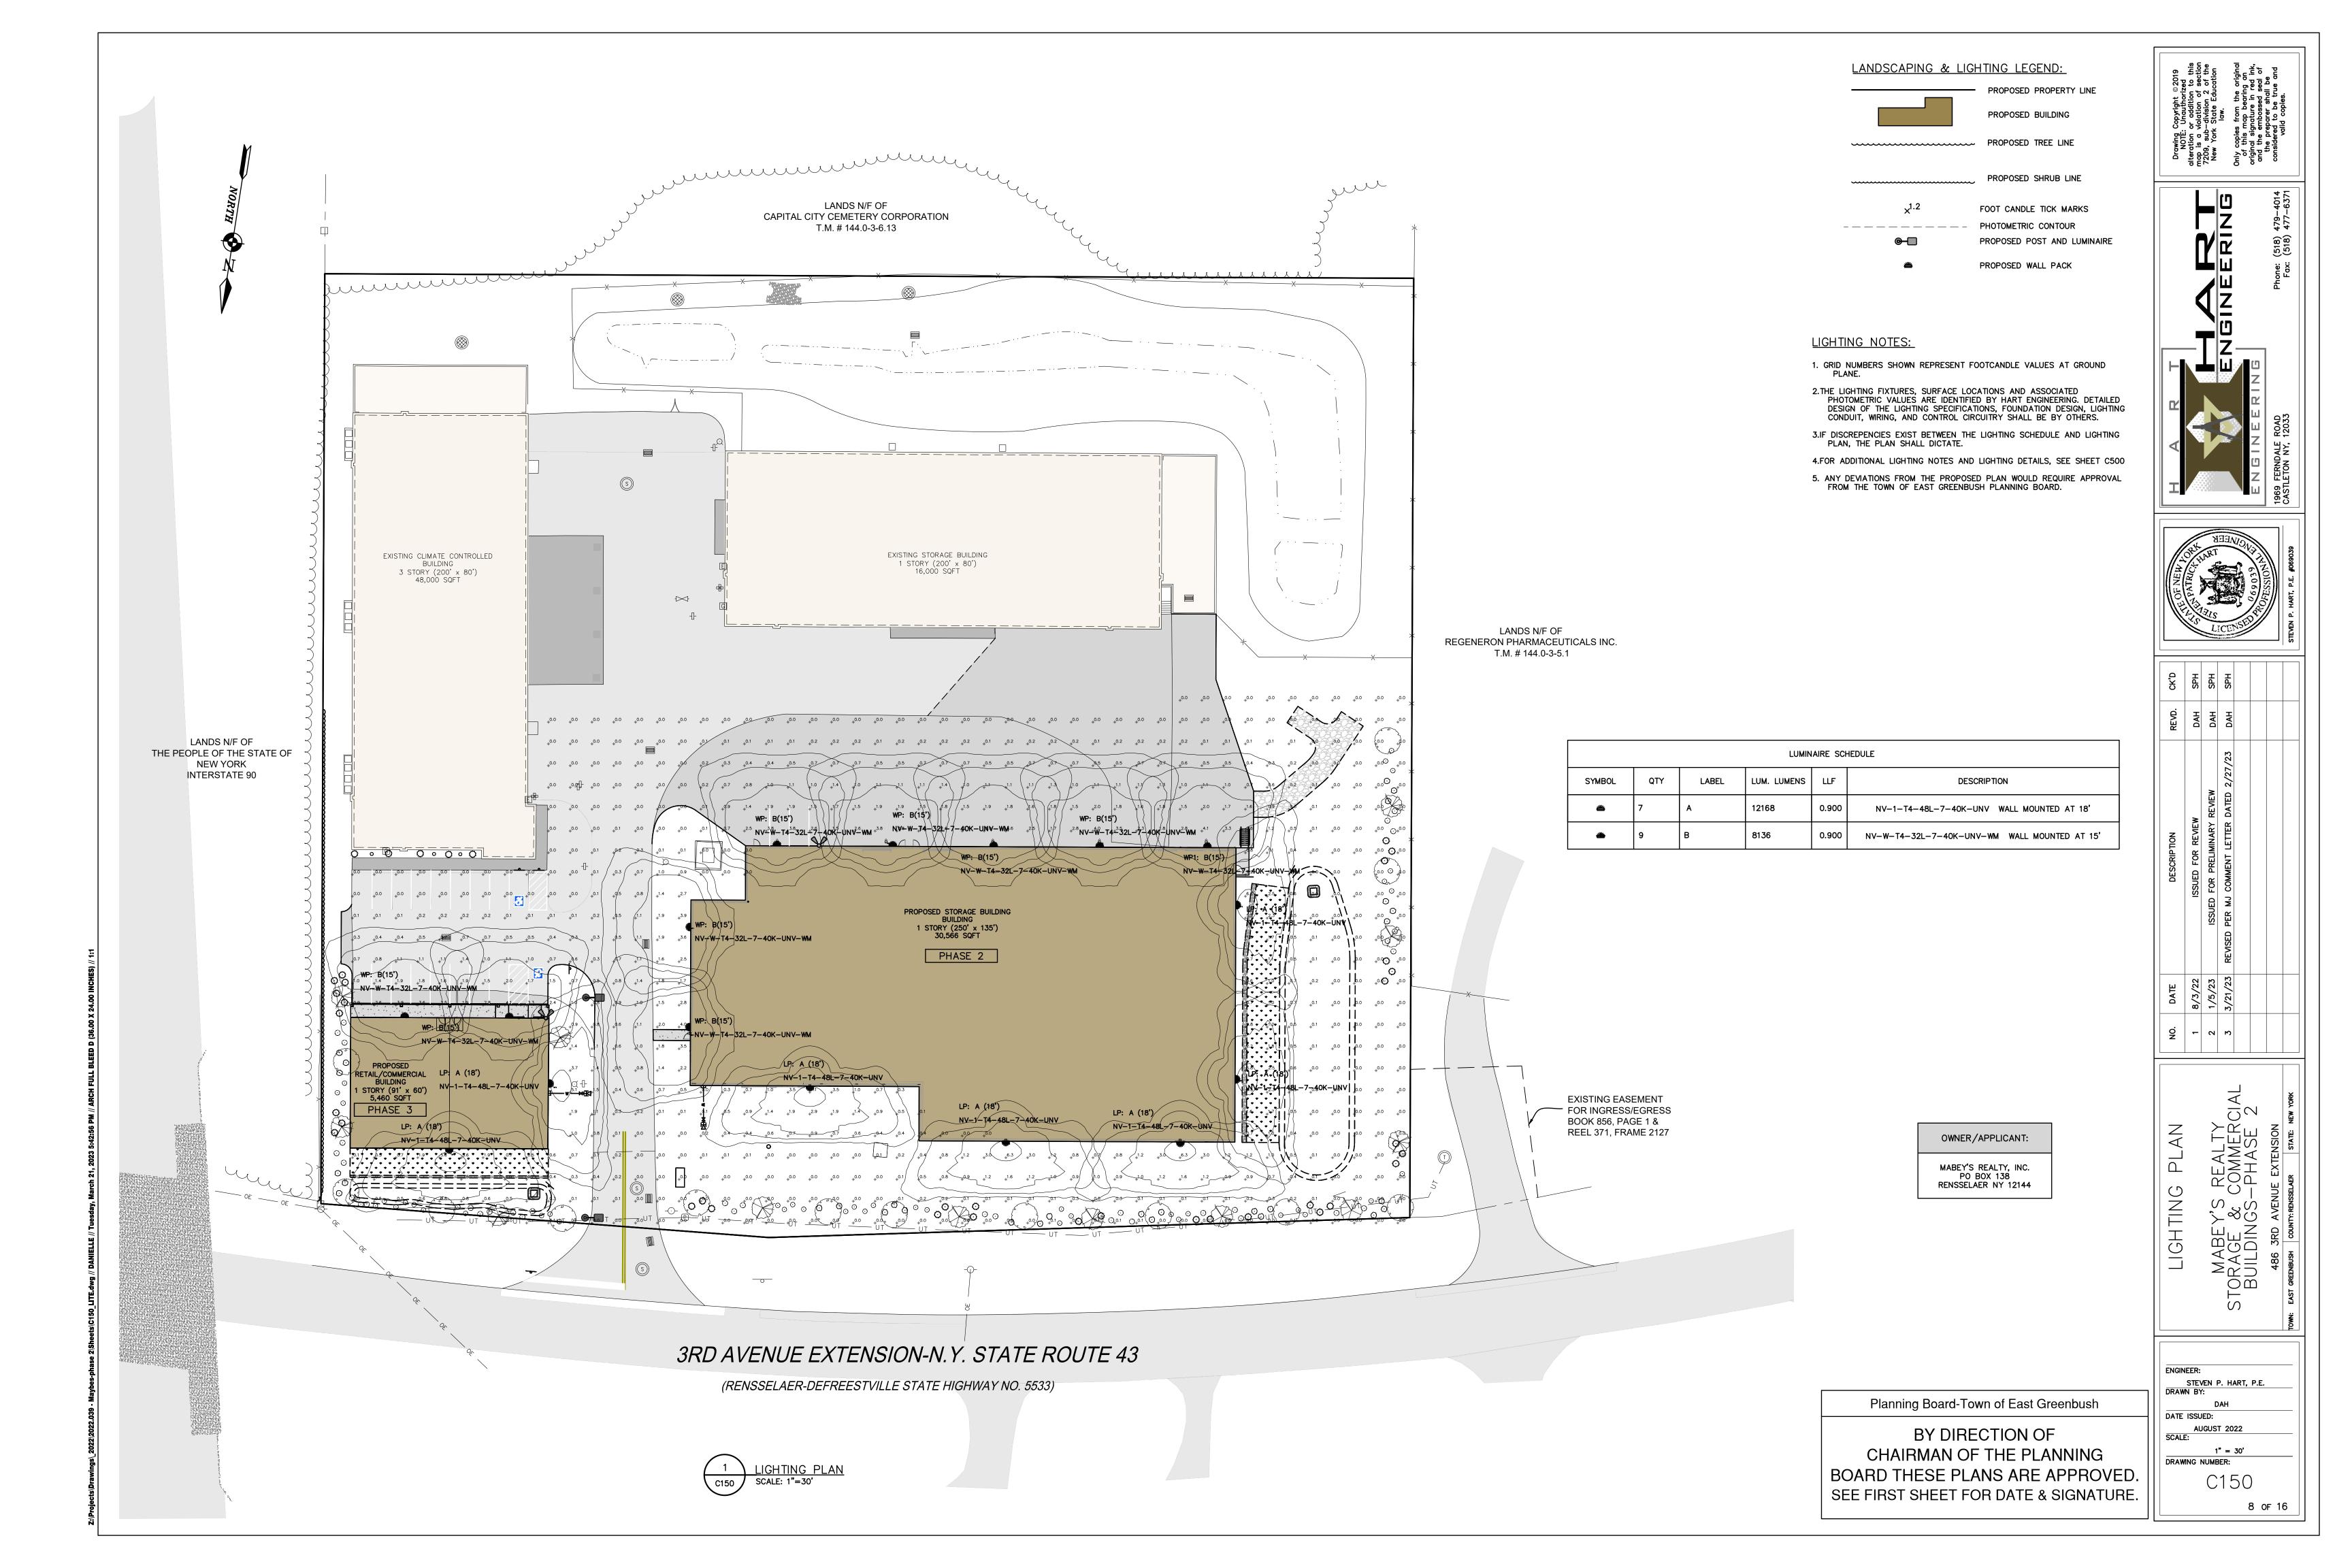

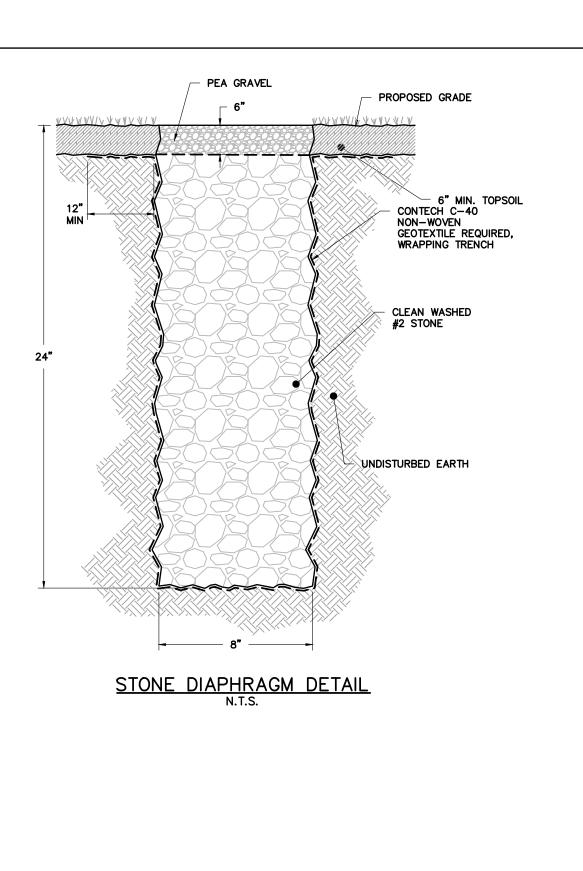

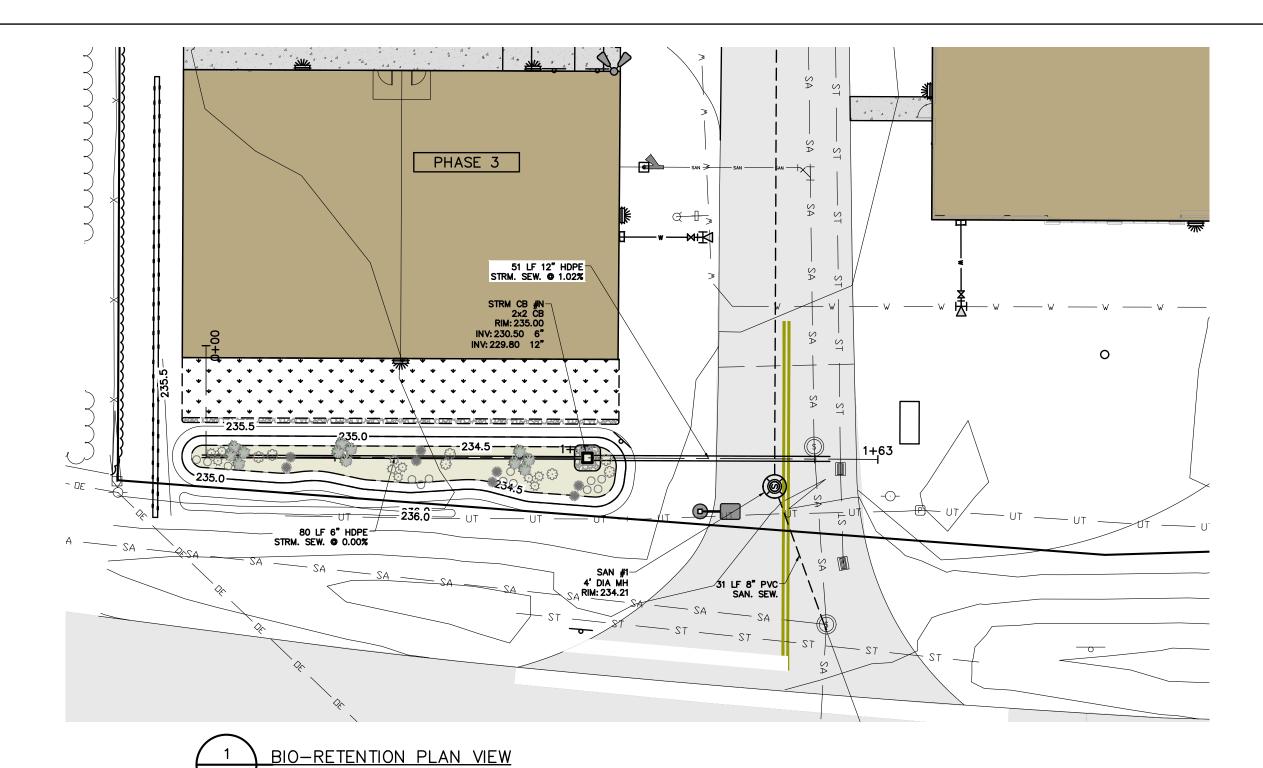

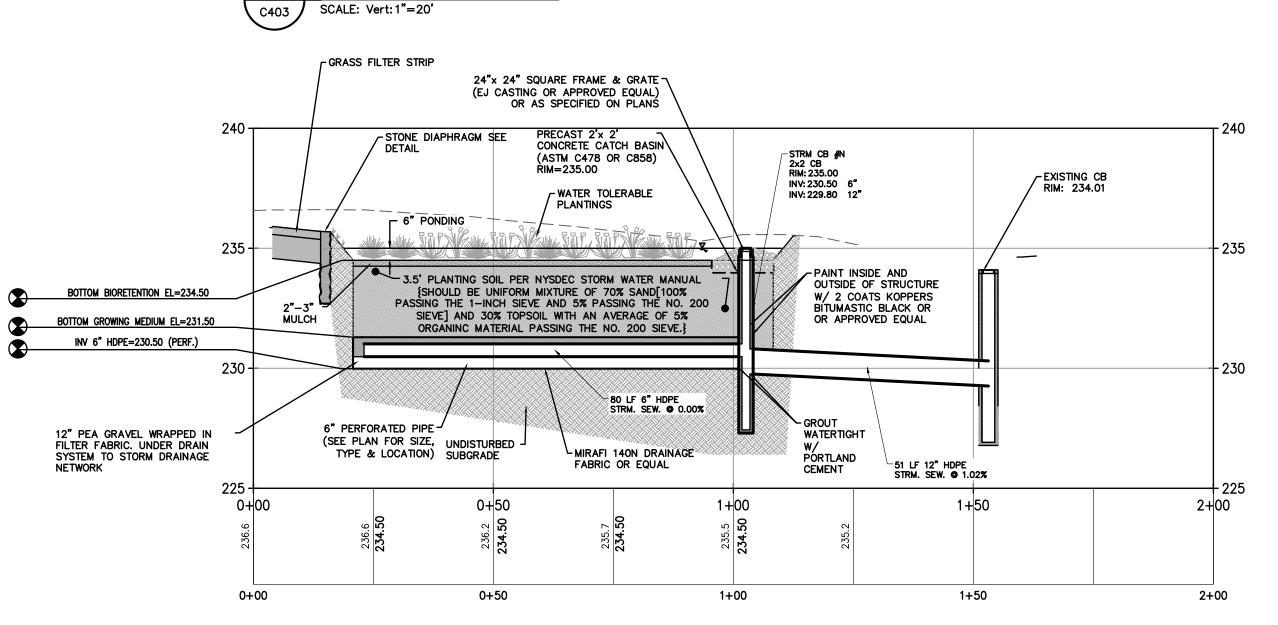



MUST BE MANTANED IN ACCORDANCE WITH O/M PLAN DO NOT REMOVE OR ALTER PROJECT DENTIFICATION NO. STORMWATER MANAGEMENT PRACTICE BIORETENTION PAINT EXPOSED SURFACE G" INSIDE DIAMETER GALVANIZED STEEL PIPE (SCHEDULE 40) PIPE SHALL CONTINUE THE LENGTH OF THE FOOTING SLOPE SLOPE FINISHED GRADE 12" 3,000 P.S.I. CONCRETE SUBGRADE

STORMWATER MANAGEMENT SIGN

TABLE 1. SUGGESTED ANNUAL MAINTENANCE ACTIVITIES FOR BIORETENTION

Maintenance Tasks	Frequency
MOWING OF GRASS FILTER STRIPS AND BIORETENTION TURF COVER	AT LEAST 4 TIMES A YEAR
SPOT WEEDING, EROSION REPAIR, TRASH REMOVAL, AND MULCH RAKING	TWICE DURING GROWING SEASON
ADD REINFORCEMENT PLANTING TO MAINTAIN DESIRED THE VEGETATION DENSITY REMOVE INVASIVE PLANTS USING RECOMMENDED CONTROL METHODS STABILIZE THE CONTRIBUTING DRAINAGE AREA TO PREVENT EROSION	AS NEEDED
SPRING INSPECTION AND CLEANUP SUPPLEMENT MULCH TO MAINTAIN A 3 INCH LAYER PRUNE TREES AND SHRUBS	ANNUALLY
REMOVE SEDIMENT IN PRE-TREATMENT CELLS AND INFLOW POINTS WHEN IT EXCEEDS 3"	ONCE EVERY 2 TO 3 YEARS
REPLACE THE MULCH LAYER	EVERY 3 YEARS

BIORETENTION PLANT MATERIAL SCHEDULE

SYM	ABRV	BOTANICAL NAME	COMMON NAME	SIZE	QTY	REMARKS
0	BJ	CALAMAGROSTIS CANADENSIS	BLUE JOINT GRASS	2" PLUGS	13	
**	IS	IRIS VERSICOLOR	BLUE FLAG IRIS	2" PLUGS	8	
♦	IV	ILEX VERCILLATA	WINTERBERRY	2 GAL.	10	CONTAINER GROWN
€	RC	PYRUS ARBUTIFOLIA	RED CHOKEBERRY	1 GAL.	7	CONTAINER GROWN
0	SA	SCIRPUS ACUTUS	HARDSTEM BULRUSH	2" PLUGS	12	


MATERIALS SPECIFICATION FOR BIORETENTION

WATERIALO OF LOR TOATION FOR BIORETENTION				
PARAMETERS	SPECIFICATIONS	SIZE	NOTES:	
PLANTINGS	SEE YOUR LOCAL NRCS STANDARD SPECIFICATIONS GUIDANCE	N/A	PLANTINGS ARE SITE-SPECIFIC	
PLANTING SOILS [4'=DEEP]	SAND 35-60% SILT 30.55% CLAY 10-25%	N/A	USDA SOIL TYPES LOAMY SAND, SANDY LOAM OR LOAM	
MULCH	UN COLORED SHREDDED HARDWOOD		AGED 6 MONTHS, MINIMUM	
PEA GRAVEL DIAPHRAGM AND CURTAIN DRAIN	PEA GRAVEL: ASTM D 448 ORNAMENTAL STONE: WASHED COBBLES	PEA GRAVEL: NO 6 STONE: 2"-5"		
GEOTEXTILE	CLASS "C" APPARENT OPPENING SIZE (ASTM-D-4751) GRAB TENSILE STREANGTH (ASTM-D-4632) BURST STRENGTH (ASTM-D-4833)	N/A	FOR USE AS NECESSARY BENEATH UNDERDRAINS ONLY	
UNDERDRAIN GRAVEL	AASHTO M-43. NO. 67.	0.25" - 0.75"	3/8" PERF. @ 6" O.C., 4 HOLES PER ROW; MINIMUM OF 3" GRAVEL OVER PIES: NOT NECESSARY UNDERNEATH PIPES	
UNDERDRAIN PIPING	ASTM D 1785 OR AASHTO M-278	6" RIDGID SCHEDULE 40 PVC	3/8" PERF. @ 6" O.C., 4 HOLES PER ROW	
POUR IN PLACE CONCRETE (IF REQUIRED)	SEE LOCAL DOT STANDARDS SPECS.; f=c=3500PSI @ 28 DAYS, NORMAL WEIGHT, AIR-ENTRAINED; RE-INFORCED TO MEET ASTM 615-60	N/A	ON-SITE TESTING OF POURED-IN-PLACE CONCRETE REQUIRED: 28 DAY STRENGTH AND SLUMP TEST: ALL CONCRETE DESIGN (CAST IN PLACE OR PRE-CAST) NOT USING PREVIOUSLY APPROVES STATE OR LOCAL STANDARDS REQUIRES DESIGN DRAWINGS SEAL \$ APPROVED BY A LICENCE PROFESSIONAL STRUCTURAL ENGINEER.	
SAND [12"=DEEP]	AASHTO M-6 OR ASTM C-33	0.02" - 0.04"	SAND SUBSTITUTION SUCH AS DIABASE GRAYSTONE #10 ARE NOT ACCEPTABLE. NO CALCIUM CARBONATE OR DOLOMITIC SAND SUBSTITUTE ARE ACCEPTABLE. NO "ROCK DUST" CAN BE USED FOR SAND	

NOTES:


- I. BIORETENTION FACILITIES SHALL BE INSTALLED AND MAINTAINED IN ACCORDANCE WITH "THE NEW YORK STATE STORMWATER MANAGEMENT DESIGN MANUAL", CHAPTER 6.
- 2. PLANTING SOIL SHALL BE TESTED \$ MEET THE FOLLOWING CRITERIA:
 PH RANGE 5.2-7.0
 ORGANIC MATTER 1.5-4%
 MAGNESIUM 35 LB/AC
 PHOSPHOROUS P₂O₅ 75LB/AC
- POTASSIUM K2O 85/AC
 SOLUBLE SALTS NOT TO EXCEED 500PPM

 IN LIEU OF PLANTING MIX, NYS DOT BIORETENTION SOIL MIX
 CAN BE UTILIZED
- 3. ROTOTILL 2-3" OF SAND BASE INTO THE BASE OF THE BIORETENTION FACILITY.
- 4. BACK FILLING OF BIORETENTION FACILITY SHALL BE PLACED IN 12" LIFTS.
- MAIN COLLECTOR PIPE OF THE UNDER DRAIN SYSTEM SHALL BE CONSTRUCTED AT A MINIMUM SLOPE OF 0.5%. OBSERVATION WELLS OR CLEAN OUT PIPES MUST BE PLACED EVERY 1000SF OF SURFACE AREA.
- 6. BIORETENTION AREA MAY NOT BE CONSTRUCTED UNTIL ALL CONTRIBUTING DRAINAGE AREA HAS BEEN STABILIZED.
- 7. ALL BIO-RETENTION BASINS SHALL BE AT A MINIMUM OF 2' ABOVE GROUND WATER.

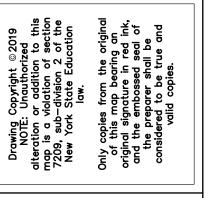

FERNDALE ROAD

Phone: (518) 479–4014

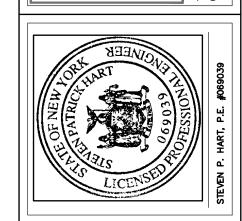

B/3/22 ISSUED FOR REVIEW 1/5/23 ISSUED FOR PRELIMINARY REVIEW 3/21/23 REVISED PER MJ COMMENT LETTER DATED 2/27/23
δ – 2 ε

BIORETENTION DETAILS—
MABEY'S REALTY
STORAGE & COMMERCIAL
BUILDINGS—PHASE 2
486 3RD AVENUE EXTENSION

Planning Board-Town of East Greenbush

BY DIRECTION OF CHAIRMAN OF THE PLANNING BOARD THESE PLANS ARE APPROVED. SEE FIRST SHEET FOR DATE & SIGNATURE. ENGINEER:

STEVEN P. HART, P.E.

DRAWN BY:

DAH

DATE ISSUED:

AUGUST 2022

SCALE:

1" = 30'

DRAWING NUMBER:

(403)

9 OF 16

BIORETENTION PLANT MATERIAL SCHEDULE

SYM	ABRV	BOTANICAL NAME	COMMON NAME	SIZE	QTY	REMARKS
0	BJ	CALAMAGROSTIS CANADENSIS	BLUE JOINT GRASS	2" PLUGS	24	
*	IS	IRIS VERSICOLOR	BLUE FLAG IRIS	2" PLUGS	30	
♦	IV	ILEX VERCILLATA	WINTERBERRY	2 GAL.	26	CONTAINER GROWN
€	RC	PYRUS ARBUTIFOLIA	RED CHOKEBERRY	1 GAL.	51	CONTAINER GROWN
٥	SA	SCIRPUS ACUTUS	HARDSTEM BULRUSH	2" PLUGS	60	

MATERIALS SPECIFICATION FOR BIORETENTION

PECIFICATIONS

PARAMETERS

3' PLANTING SOIL PER NYSDEC STORM WATER MANUAL ¬ {SHOULD BE UNIFORM MIXTURE OF 70% SAND[100% PASSING THE 1-INCH SIEVE AND 5% PASSING THE NO. 200 SIEVE] AND 30% TOPSOIL WITH AN AVERAGE OF 5% ORGANINC MATERIAL PASSING THE NO. 200 SIEVE. 7 24"x 24" SQUARE FRAME & GRATE (EJ CASTING OR APPROVED EQUAL) OR AS SPECIFIED ON PLANS STONE DIAPHRAGM SEE ~ 240 -**TOLERABLE** - GROUT WATERTIGHT GRASS FILTER STRIP W/ PORTLAND CEMENT + 235 12" PEA GRAVEL WRAPPED IN FILTER FABRIC. UNDER DRAIN SYSTEM TO STORM DRAINAGE NETWORK + 230 INV 6" HDPE=228.80 PERF.) 115 LF 6" HDPE STRM. SEW. @ 0.00% UNDISTURBED -SUBGRADE 225 -PAINT INSIDE AND -OUTSIDE OF STRUCTURE STRM CB #P 2x2 CB RIM: 233.30 INV: 228.80 6" INV: 228.80 12" MIRAFI 140N 6" PERFORATED PIPE DRAINAGE FABRIC OR EQUAL (SEE PLAN FOR SIZE, TYPE & LOCATION) W/ 2 COATS KOPPERS BITUMASTIC BLACK OR OR APPROVED EQUAL 2+00 2+10 0+00 0+50 1+00 1+50 0+00 1+50 2+00 2+10

BIO-RETENTION SECTION VIEW SCALE: Vert: 1"=4' Hor: 1"=20'

TABLE 1. SUGGESTED ANNUAL MAINTENANCE ACTIVITIES FOR BIORETENTION


Maintenance Tasks	Frequency
MOWING OF GRASS FILTER STRIPS AND BIORETENTION TURF COVER	AT LEAST 4 TIMES A YEAR
SPOT WEEDING, EROSION REPAIR, TRASH REMOVAL, AND MULCH RAKING	TWICE DURING GROWING SEASON
ADD REINFORCEMENT PLANTING TO MAINTAIN DESIRED THE VEGETATION DENSITY REMOVE INVASIVE PLANTS USING RECOMMENDED CONTROL METHODS STABILIZE THE CONTRIBUTING DRAINAGE AREA TO PREVENT EROSION	AS NEEDED
SPRING INSPECTION AND CLEANUP SUPPLEMENT MULCH TO MAINTAIN A 3 INCH LAYER PRUNE TREES AND SHRUBS	ANNUALLY
REMOVE SEDIMENT IN PRE-TREATMENT CELLS AND INFLOW POINTS WHEN IT EXCEEDS 3"	ONCE EVERY 2 TO 3 YEARS
REPLACE THE MULCH LAYER	EVERY 3 YEARS

SEE YOUR LOCAL NRCS STANDARD SPECIFICATIONS GUIDANCE PLANTINGS PLANTINGS ARE SITE-SPECIFIC SAND 35-60% SILT 30.55% CLAY 10-25% PLANTING SOILS USDA SOIL TYPES LOAMY SAND, SANDY LOAM OR LOAM [4'=DEEP] PEA (

SIZE

NOTES:

JLCH	UN COLORED SHREDDED HARDWOOD		AGED 6 MONTHS, MINIMUM
A GRAVEL DIAPHRAGM D CURTAIN DRAIN	PEA GRAVEL: ASTM D 448 ORNAMENTAL STONE: WASHED COBBLES	PEA GRAVEL: NO 6 STONE: 2"-5"	
OTEXTILE	CLASS "C" APPARENT OPPENING SIZE (ASTM-D-475 I) GRAB TENSILE STREANGTH (ASTM-D-4632) BURST STRENGTH (ASTM-D-4833)	N/A	FOR USE AS NECESSARY BENEATH UNDERDRAINS ONLY
IDERDRAIN GRAVEL	AASHTO M-43. NO. 67.	0.25" - 0.75"	3/8" PERF. @ 6" O.C., 4 HOLES PER ROW; MINIMUM OF 3" GRAVEL OVER PIES: NOT NECESSARY UNDERNEATH PIPES
DERDRAIN PIPING	ASTM D 1785 OR AASHTO M-278	6" RIDGID SCHEDULE 40 PVC	3/8" PERF. @ G" O.C., 4 HOLES PER ROW
OUR IN PLACE CONCRETE REQUIRED)	SEE LOCAL DOT STANDARDS SPECS.; f=c=3500PSI @ 28 DAYS, NORMAL WEIGHT, AIR-ENTRAINED; RE-INFORCED TO MEET ASTM 615-60	N/A	ON-SITE TESTING OF POURED-IN-PLACE CONCRETE REQUIRED: 28 DAY STRENGTH AND SLUMP TEST: ALL CONCRETE DESIGN (CAST IN PLACE OR PRE-CAST) NOT USING PREVIOUSLY APPROVES STATE OR LOCAL STANDARDS REQUIRES DESIGN DRAWINGS SEAL & APPROVED BY A LICENCE PROFESSIONAL STRUCTURAL ENGINEER.
ND 2"=DEEP]	AASHTO M-6 OR ASTM C-33	0.02" - 0.04"	SAND SUBSTITUTION SUCH AS DIABASE GRAYSTONE #10 ARE NOT ACCEPTABLE. NO CALCIUM CARBONATE OR DOLOMITIC SAND SUBSTITUTE ARE ACCEPTABLE. NO "ROCK DUST" CAN BE USED FOR SAND

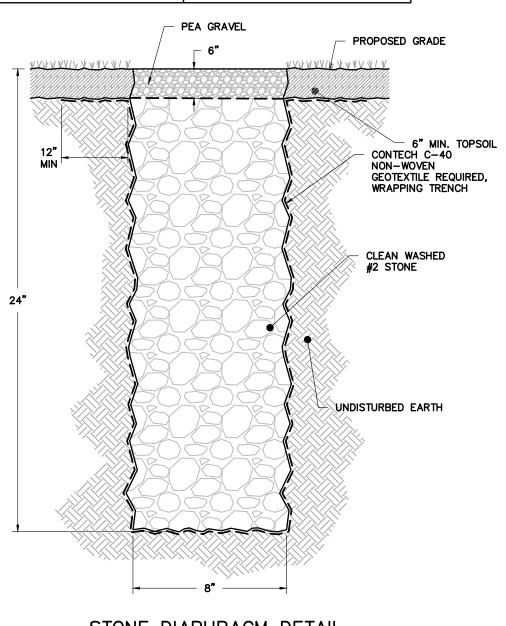

STONE DIAPHRAGM DETAIL N.T.S.

MUST BE MAINTAINED IN ACCORDANCE WITH O/M PLAN DO NOT REMOVE OR ALTER PROJECT IDENTIFICATION NO. STORMWATER MANAGEMENT PRACTICE -**BIORETENTION** 6" INSIDE DIAMETER GALVANIZED STEEL PIPE (SCHEDULE 40) PIPE SHALL CONTINUE THE LENGTH OF THE FOOTING SLOPE CONCRETE SURFACE FOR POSITIVE FINISHED GRADE 3,000 P.S.I. CONCRETE ► SUBGRADE

STORMWATER MANAGEMENT SIGN


I. BIORETENTION FACILITIES SHALL BE INSTALLED AND MAINTAINED IN ACCORDANCE WITH "THE NEW YORK STATE STORMWATER MANAGEMENT DESIGN MANUAL", CHAPTER 6.


2. PLANTING SOIL SHALL BE TESTED \$ MEET THE FOLLOWING CRITERIA:


- PH RANGE 1.5-4% 35 LB/AC 75LB/AC ORGANIC MATTER MAGNESIUM PHOSPHOROUS P2O5 POTASSIUM K2O SOLUBLE SALTS NOT TO EXCEED 500PPM * IN LIEU OF PLANTING MIX, NYS DOT BIORETENTION SOIL MIX CAN BE UTILIZED
- 3. ROTOTILL 2-3" OF SAND BASE INTO THE BASE OF THE BIORETENTION FACILITY.
- 4. BACK FILLING OF BIORETENTION FACILITY SHALL BE PLACED IN 12"
- 5. MAIN COLLECTOR PIPE OF THE UNDER DRAIN SYSTEM SHALL BE CONSTRUCTED AT A MINIMUM SLOPE OF 0.5%. OBSERVATION WELLS OR CLEAN OUT PIPES MUST BE PLACED EVERY 1000SF OF SURFACE AREA.
- 6. BIORETENTION AREA MAY NOT BE CONSTRUCTED UNTIL ALL CONTRIBUTING DRAINAGE AREA HAS BEEN STABILIZED.
- 7. ALL BIO-RETENTION BASINS SHALL BE AT A MINIMUM OF 2' ABOVE GROUND WATER.

Planning Board-Town of East Greenbush BY DIRECTION OF

CHAIRMAN OF THE PLANNING BOARD THESE PLANS ARE APPROVED. SEE FIRST SHEET FOR DATE & SIGNATURE.

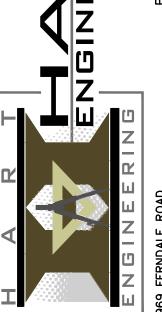

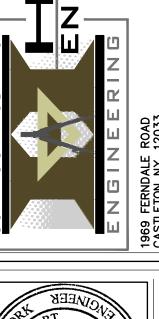

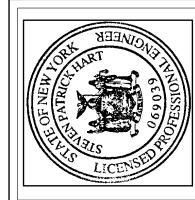



REVD. CK'D	DAH SPH	M DAH SPH	2/27/23 DAH SPH		
DESCRIPTION	ISSUED FOR REVIEW	ISSUED FOR PRELIMINARY REVIEW	REVISED PER MJ COMMENT LETTER DATED 2/27/23		
DATE	8/3/22	1/5/23	3/21/23		
NO.	-	2	ы		

DETAILS. TENTION BIORE-

ENGINEER: STEVEN P. HART, P.E.
DRAWN BY: DATE ISSUED: SCALE:

DRAWING NUMBER:

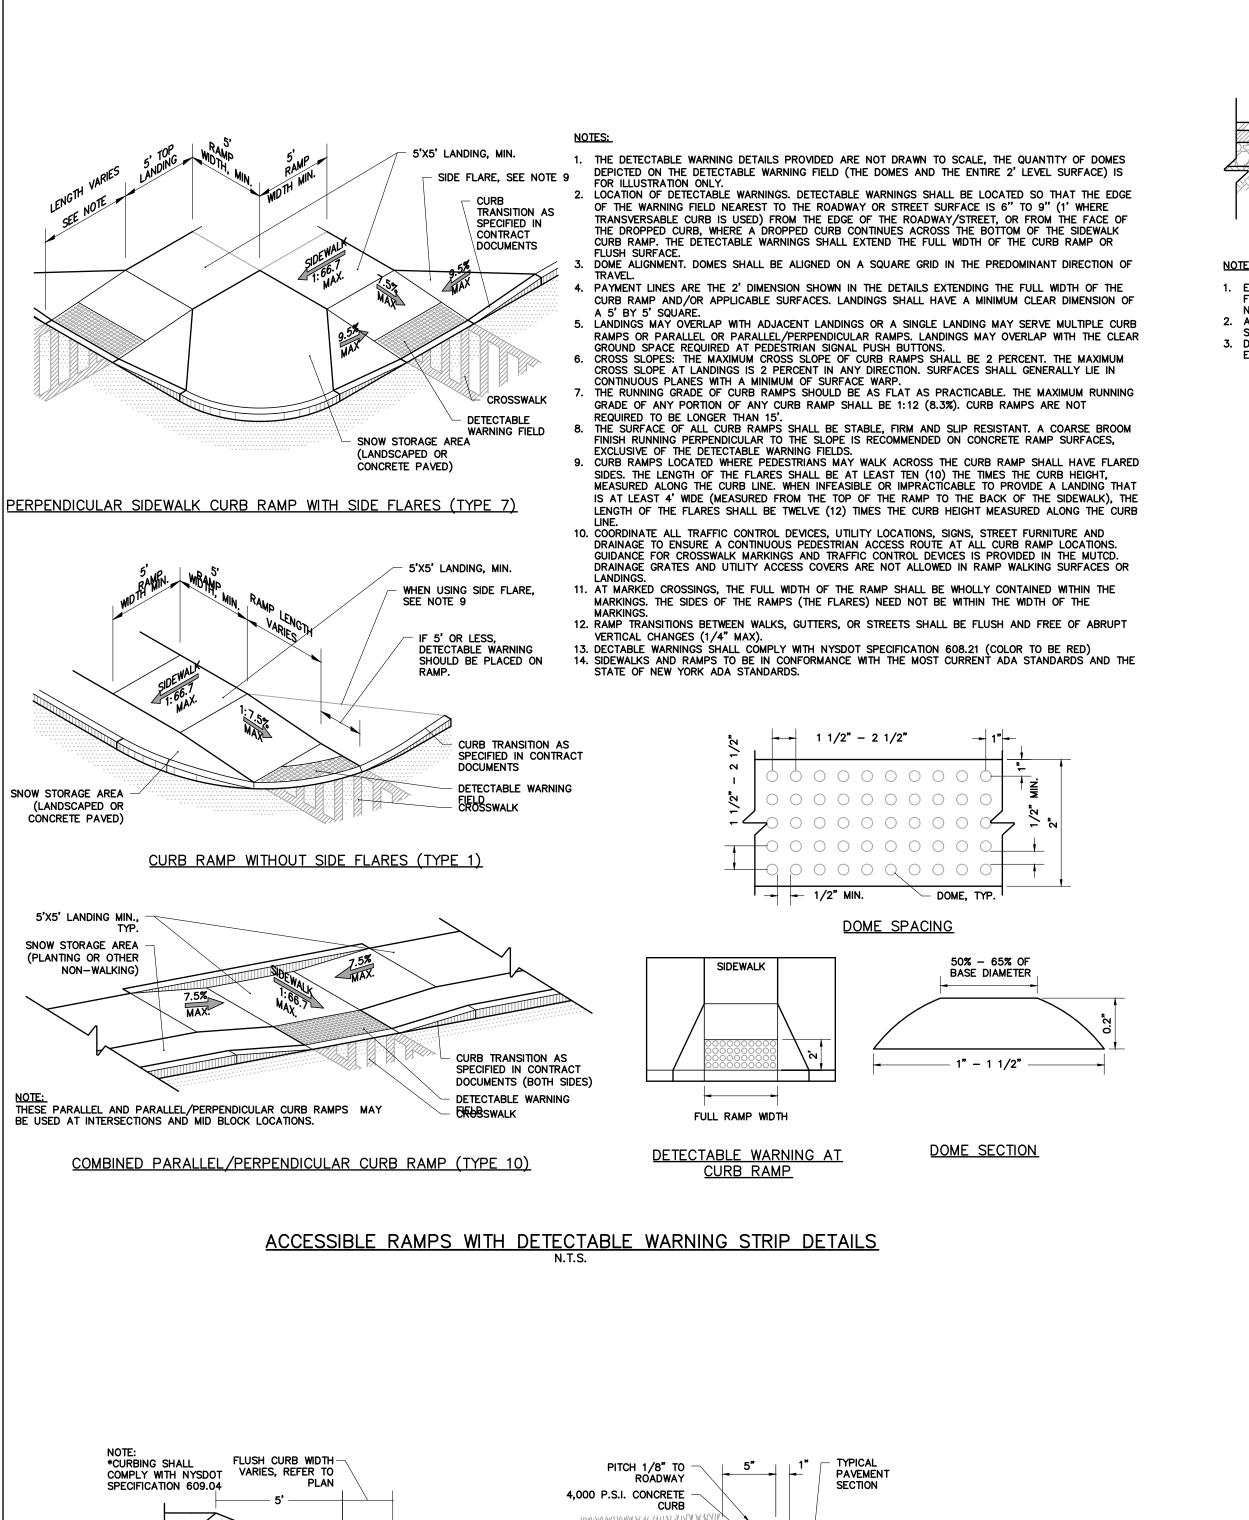

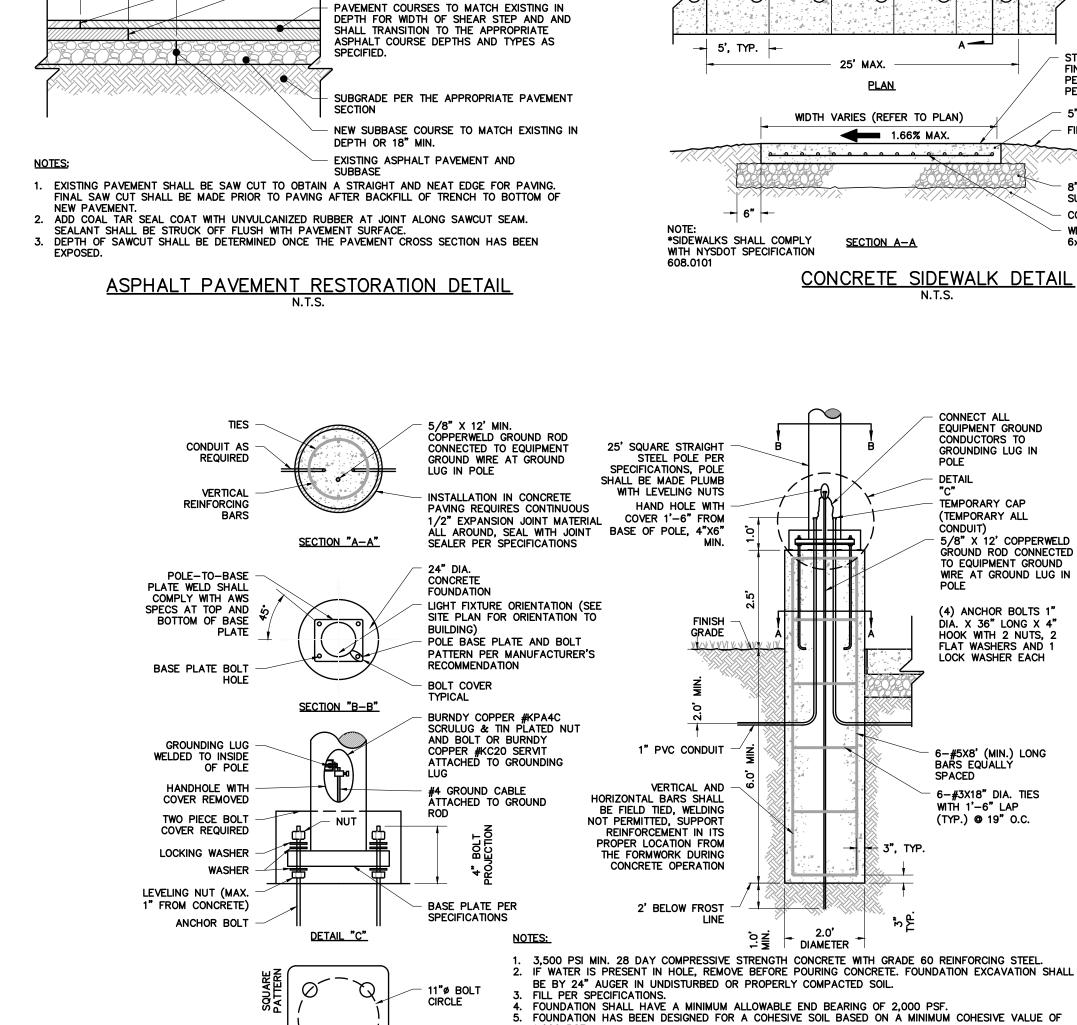


TYPICAL ANCHOR BOLT SPACING

LIMIT OF SAWCUT

CAP SEAM WITH BITUMINOUS SEALER (SEE

SITE LUMINAIRE FOUNDATION DETAIL (ROUND BASE)

7. EXPOSED CONCRETE SHALL BE PAINTED TRAFFIC YELLOW.

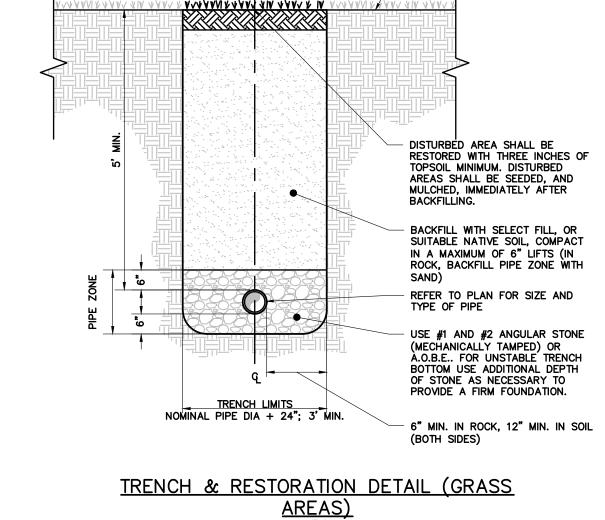

DEXPANSION JOINT WITH

(2) CONTRACTION JOINT

STIFF BRISTLE-BROOM

PERPENDICULAR TO

FINISHED GRADE

PEDESTRIAN TRAFFIC

5" 3,500 PSI CONCRETE

8" D.O.T. ITEM 304.12 SUB- BASE

COMPACTED SUBGRADE

WELDED WIRE MESH 6x6-W2.9xW2.9

CONDUCTORS TO

TEMPORARY CAP

(TEMPORARY ALL

TO EQUIPMENT GROUND

(4) ANCHOR BOLTS 1"

DIA. X 36" LONG X 4"

HOOK WITH 2 NUTS, 2

FLAT WASHERS AND

LOCK WASHER EACH


WITH 1'-6" LAP

(TYP.) @ 19" O.C.

WIRE AT GROUND LUG IN


GROUNDING LUG IN


AREAS) N.T.S.

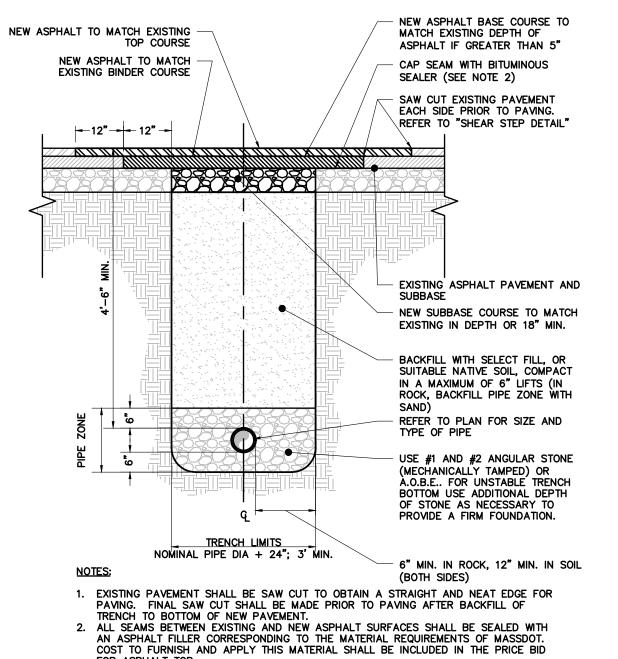



TRENCH & RESTORATION DETAIL (PAVED AREAS) N.T.S.

3. HIGHWAY INSPECTION MAY REQUIRE 10' WIDE SURFACE REPAIR AS FIELD DETERMINED.

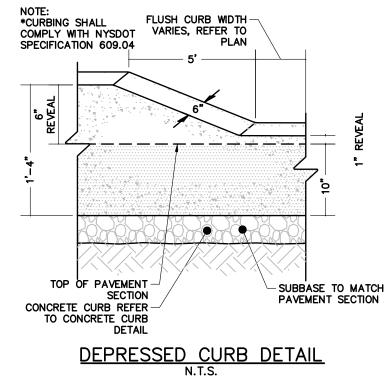

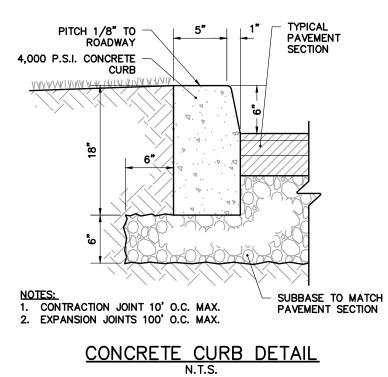

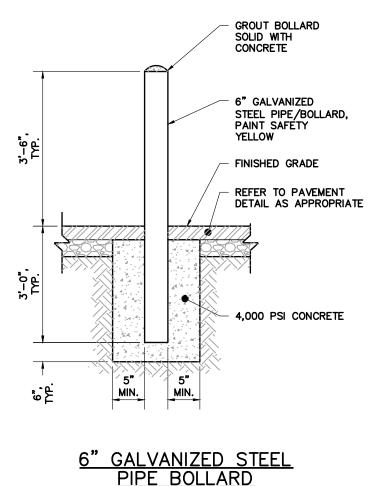

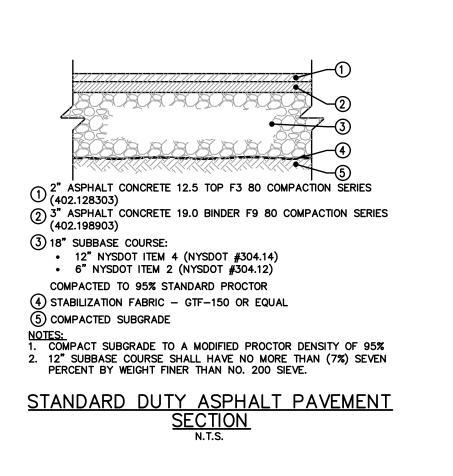

6. FOUNDATION HAS BEEN DESIGNED FOR A GRANULAR SOIL BASED ON A MINIMUM LATERAL SOIL

PRESSURE OF 1,000 PSF, UTILIZING AASHTO FIGURE 1.8.2C(4) OF "EMBEDMENT OF POSTS WITH


Planning Board-Town of East Greenbush


BY DIRECTION OF CHAIRMAN OF THE PLANNING BOARD THESE PLANS ARE APPROVED SEE FIRST SHEET FOR DATE & SIGNATURE

 \mathcal{O} A SITE


ENGINEER: STEVEN P. HART, P.E. DRAWN BY: DATE ISSUED: SCALE:

DRAWING NUMBER: 11 OF 16

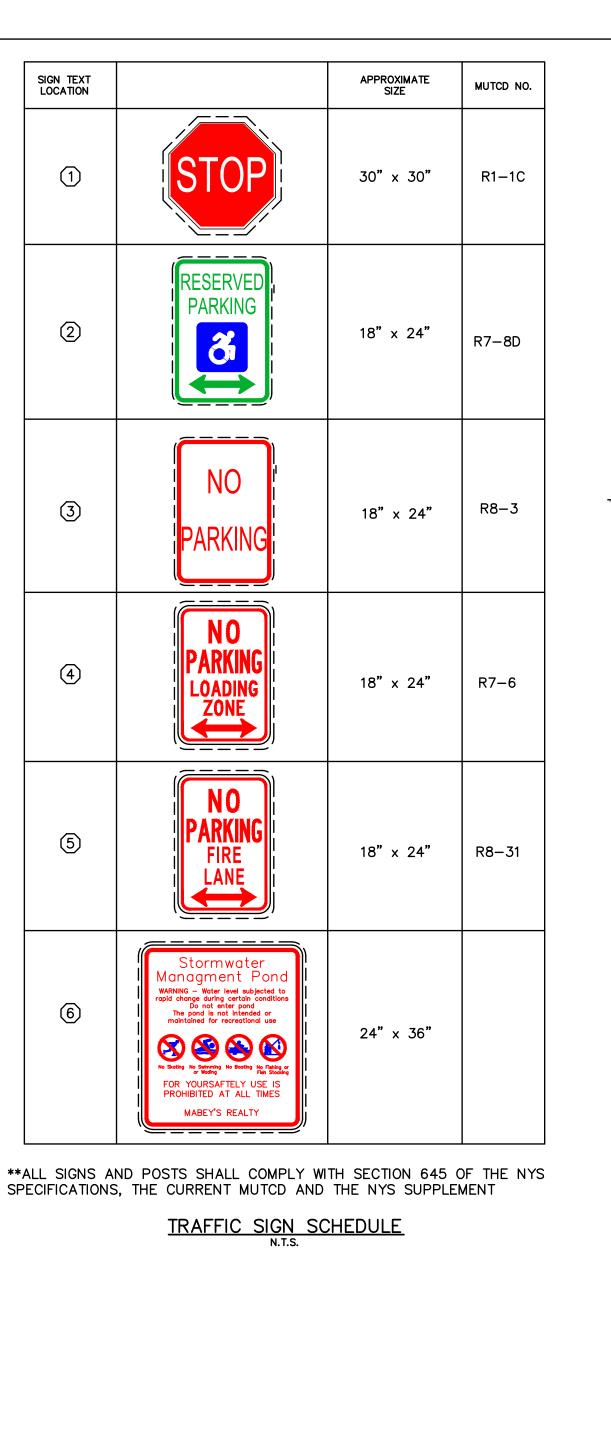

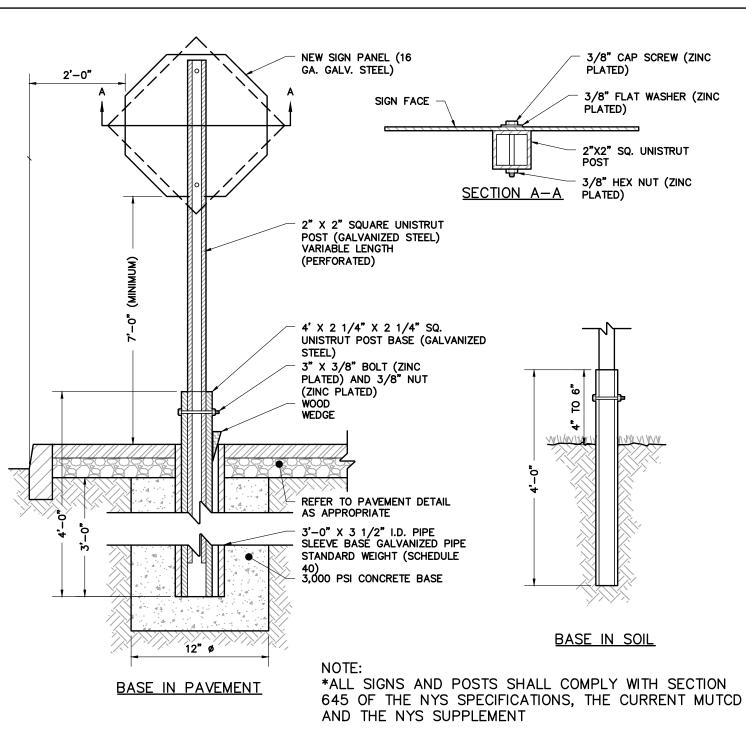

TYPICAL POST MOUNT SIGN INSTALLATION

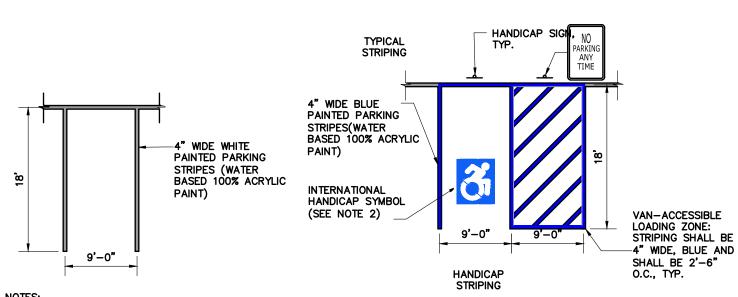


NOTES:
1. ALL DIMENSIONS SHALL BE IN ACCORDANCE WITH ADA STANDARD AND CURRENT ZONING AND SITE REGULATIONS. 2. PAINTED HANDICAP SYMBOL TO BE IN ACCORDANCE W/ ADA STANDARDS

3. SLOPE OF PAVEMENT SURFACE IN HANDICAP PARKING AREA SHALL NOT EXCEED 2% IN ANY DIRECTION.


4. SEE PLAN FOR ACTUAL LOCATION OF SIGNAGE

PAVEMENT MARKING DETAIL-PARKING STRIPING

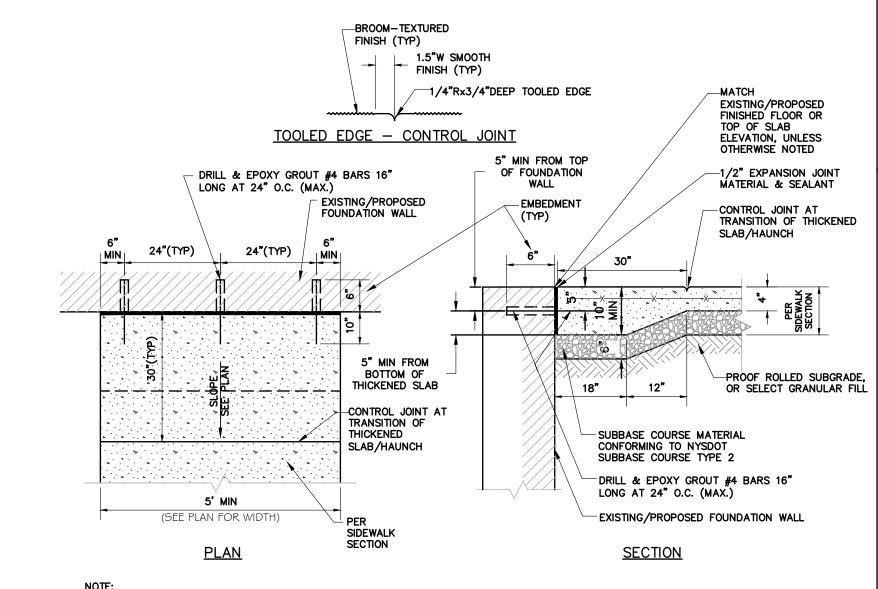


- 1. THICKENED (HAUNCH) & ADDITIONALLY REINFORCED CONCRETE SIDEWALK ENDS
- ARE REQUIRED AT ALL EXISTING/PROPOSED BUILDING ENTRANCES. 2. SEE CONCRETE SIDEWALK DETAIL FOR ADDITIONAL DETAILS & NOTES.


CONCRETE SIDEWALK AT BUILDING ENTRANCES

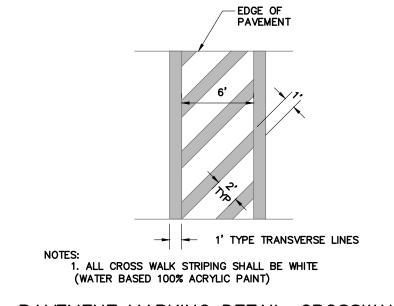

PAVEMENT MARKING DETAIL-CROSSWALK **STRIPING**

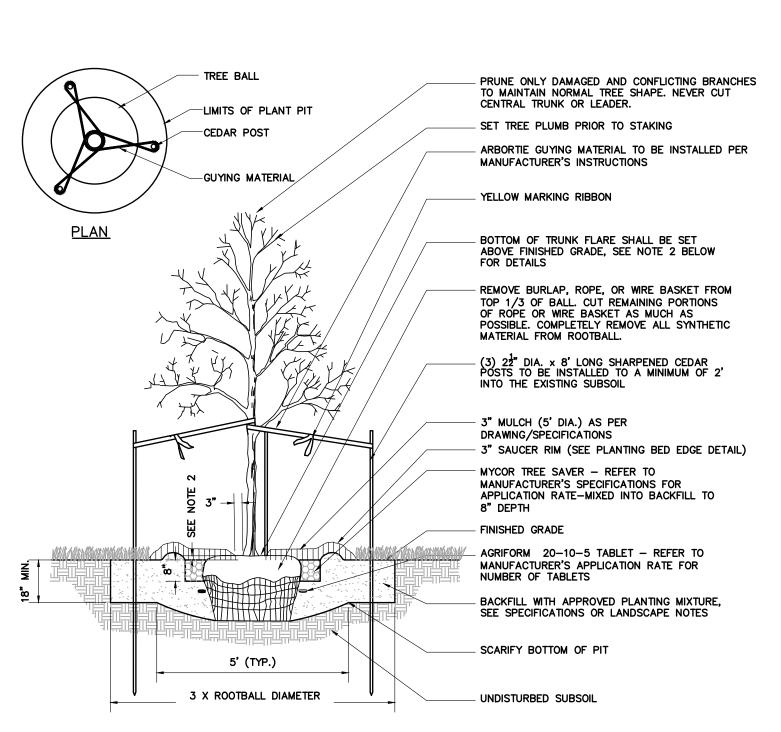

- 1. MAINTAIN A 3" MINIMUM RADIUS CLEAR OF MULCH AROUND THE TRUNK.
- 2. THE DISTANCE BETWEEN THE BOTTOM OF THE TRUNK FLARE AND THE FINISHED GRADE SHALL BE AS FOLLOWS: FOR SANDY OR LOAMY SOILS: 1" FOR CLAY OR POORLY DRAINED SOILS: 3"
 THE CONTRACTOR SHALL REVIEW THE APPROPRIATE PLANTING DEPTH WITH THE
- OWNER'S REPRESENTATIVE PRIOR TO INSTALLATION. 3. WHEN TAGGING TREES AT THE NURSERY, MARK THE NORTH SIDE OF THE TREE IN THE FIELD AND WHEN INSTALLING, ROTATE TREE TO FACE NORTH WHENEVER POSSIBLE.

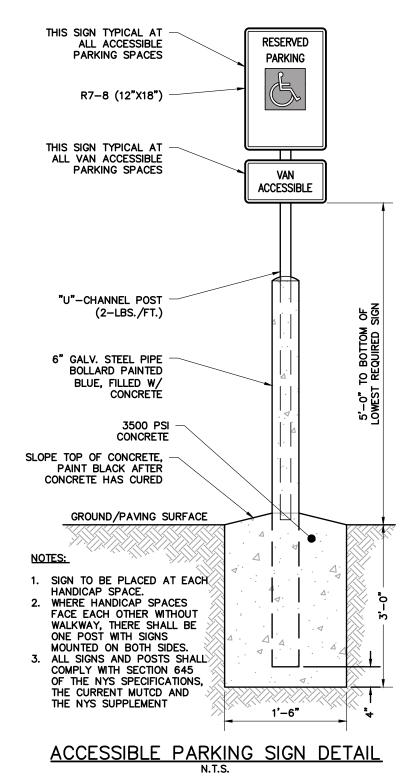


Planning Board-Town of East Greenbush

BY DIRECTION OF CHAIRMAN OF THE PLANNING BOARD THESE PLANS ARE APPROVED SEE FIRST SHEET FOR DATE & SIGNATURE \sim \mathcal{O} A 1 $\overline{\mathbb{S}}$ \odot m


REVD. DAH DAH

ENGINEER: DRAWN BY: DATE ISSUED: SCALE:

DRAWING NUMBER: 12 of 16

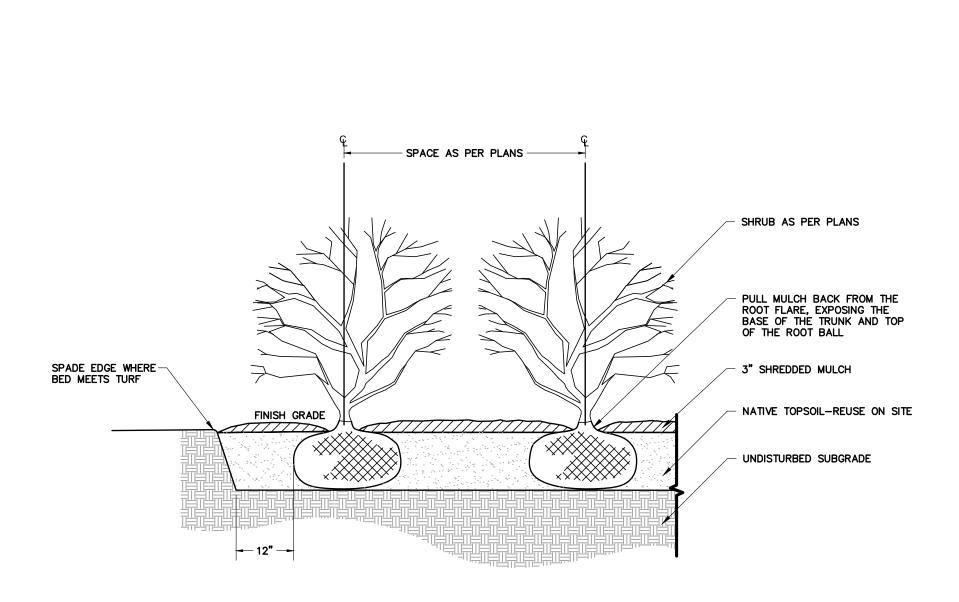


SHRUB PLANTING N.T.S.

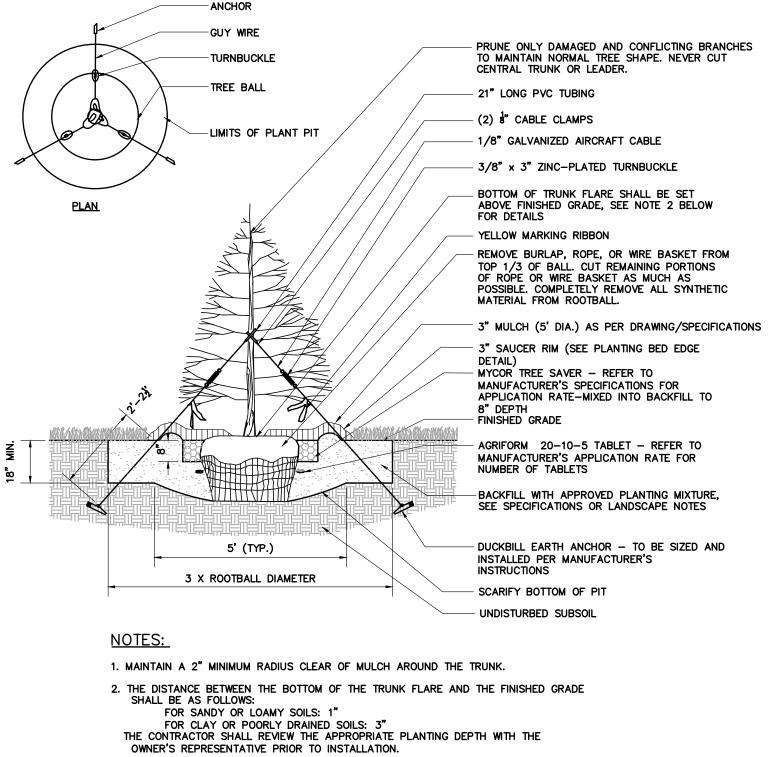


3. WHEN TAGGING TREES AT THE NURSERY, MARK THE NORTH SIDE OF THE TREE IN THE FIELD AND WHEN INSTALLING, ROTATE TREE TO FACE NORTH WHENEVER POSSIBLE.

EVERGREEN TREE PLANTING
N.T.S.


DECIDUOUS TREE PLANTING LESS THAN 4" CAL.
N.T.S.

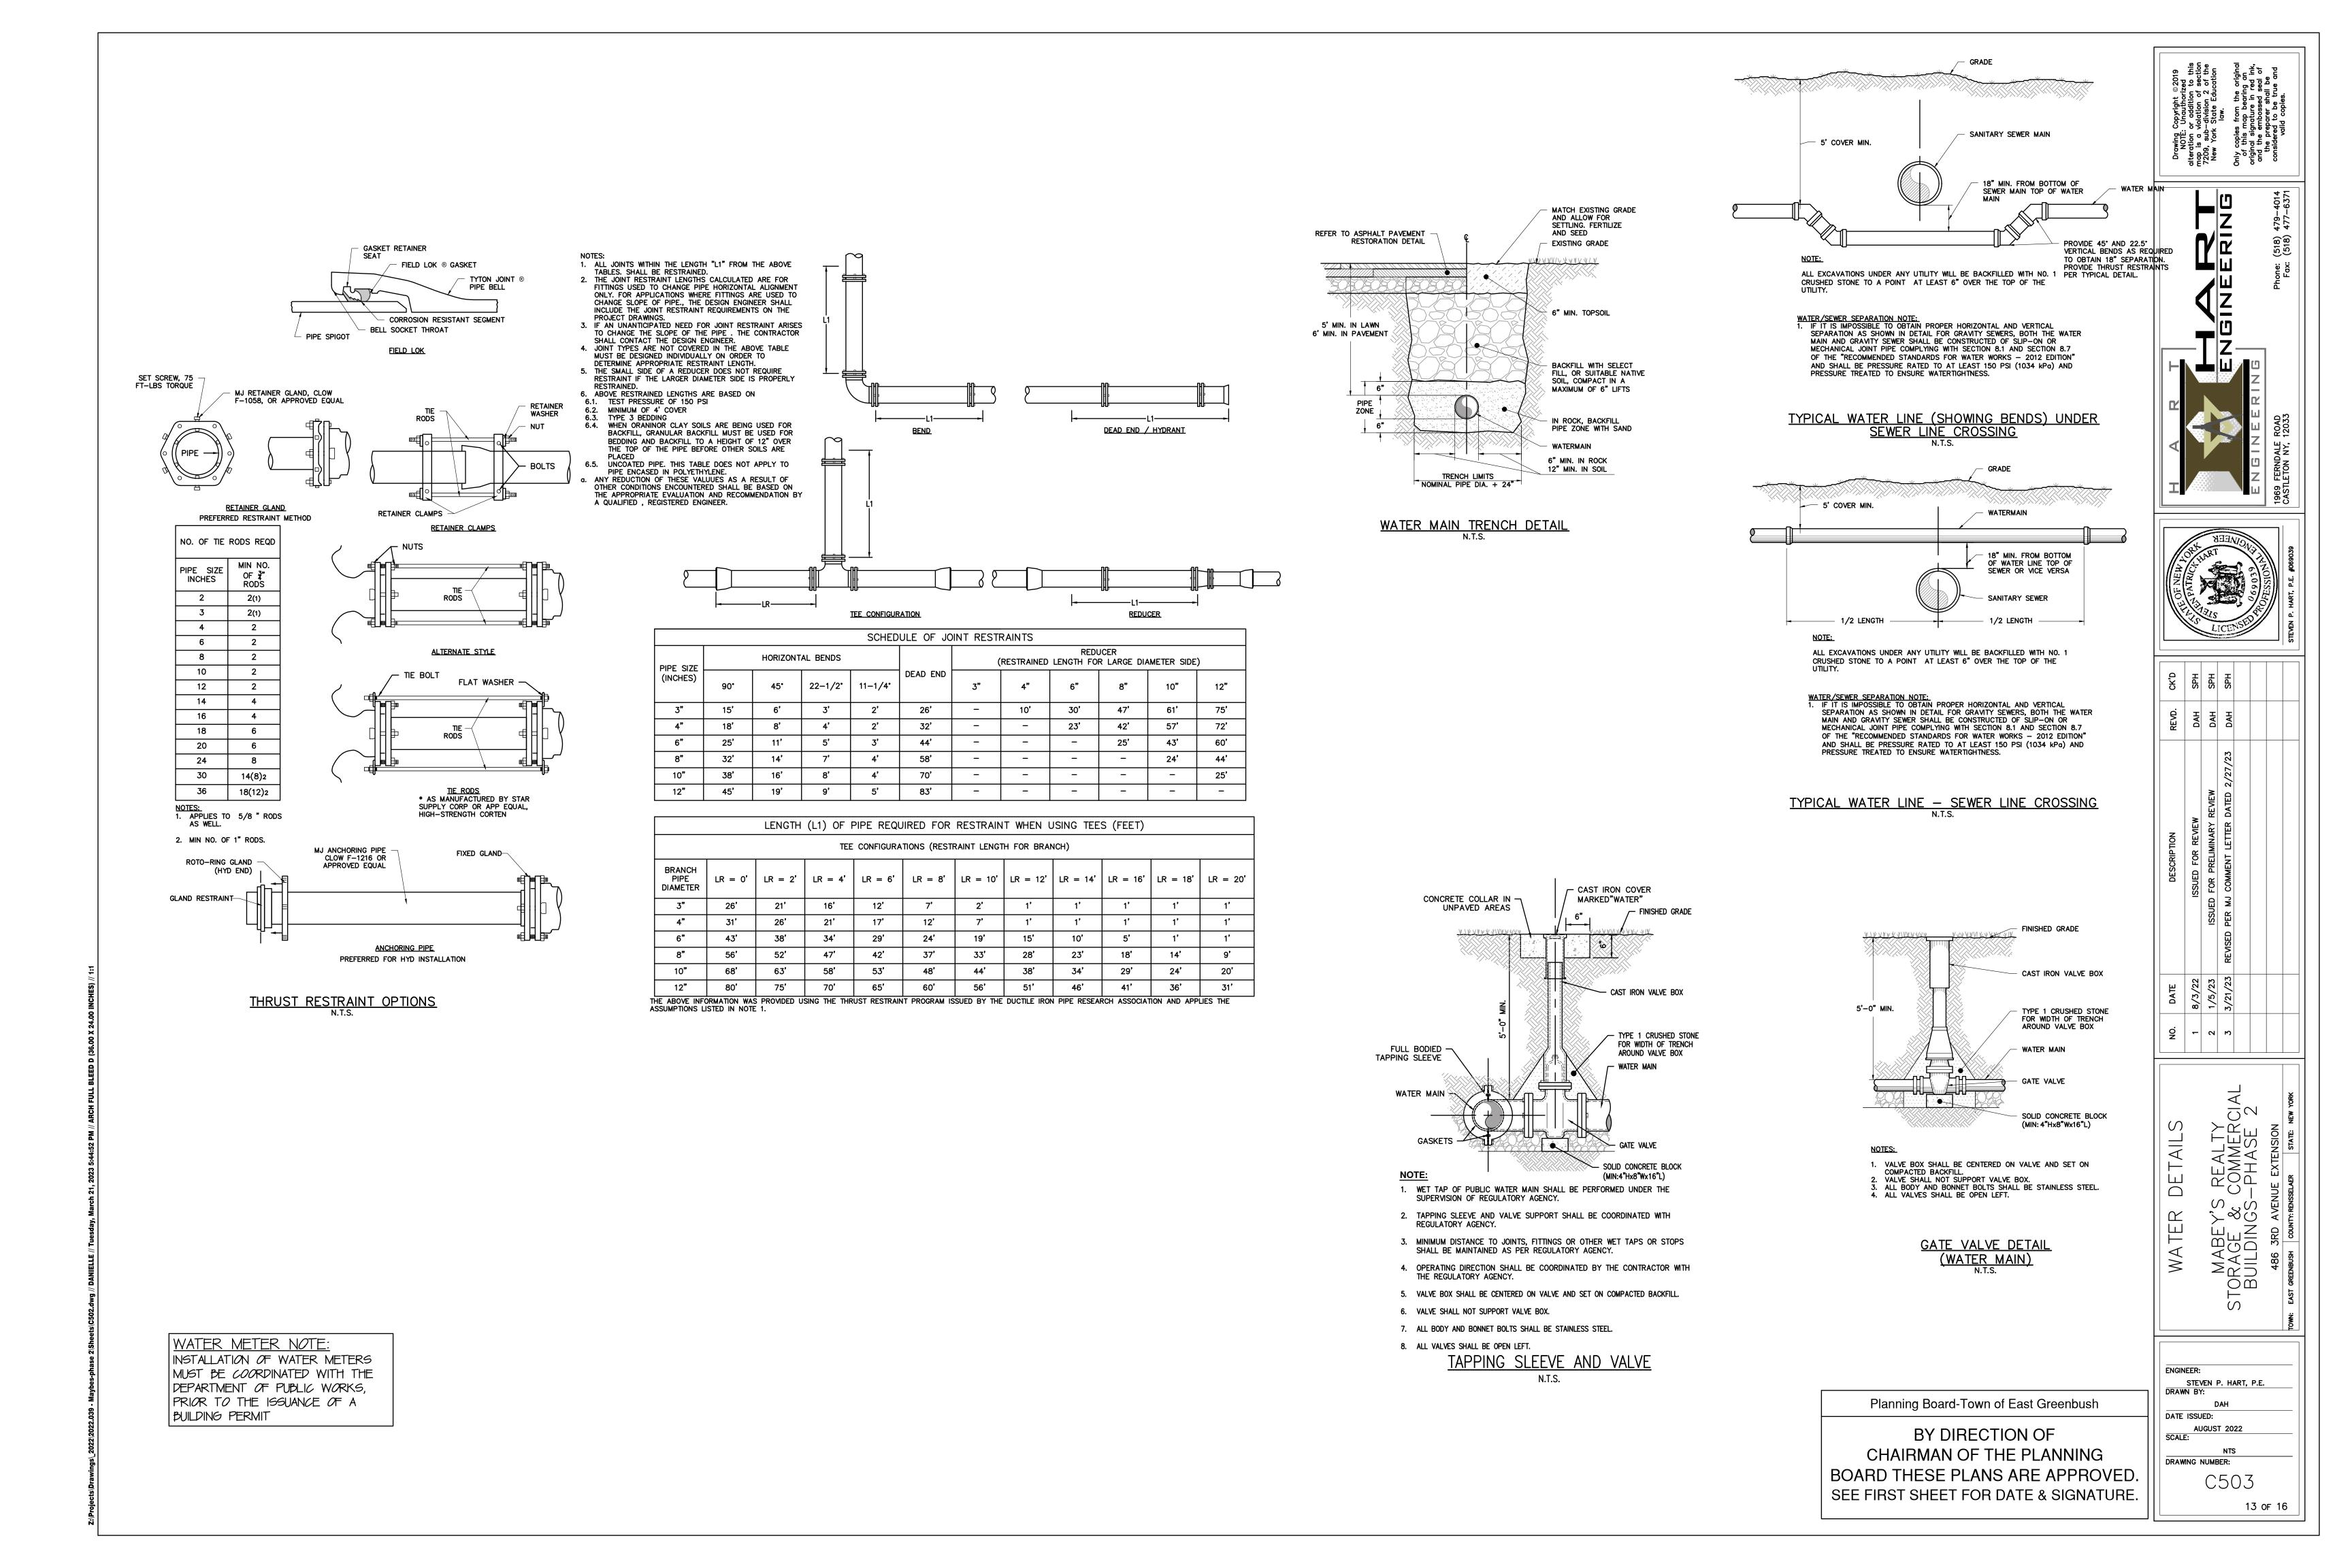


NOTE: ALL SEWER MATERIALS AND WORKMANSHIP SHALL COMPLY WITH THE TOWNS SEWER REGULATIONS. IN ADDITION THE TOWNS DPW MAY REQUIRE ADDITIONAL MODIFICATIONS DURING CONSTRUCTION

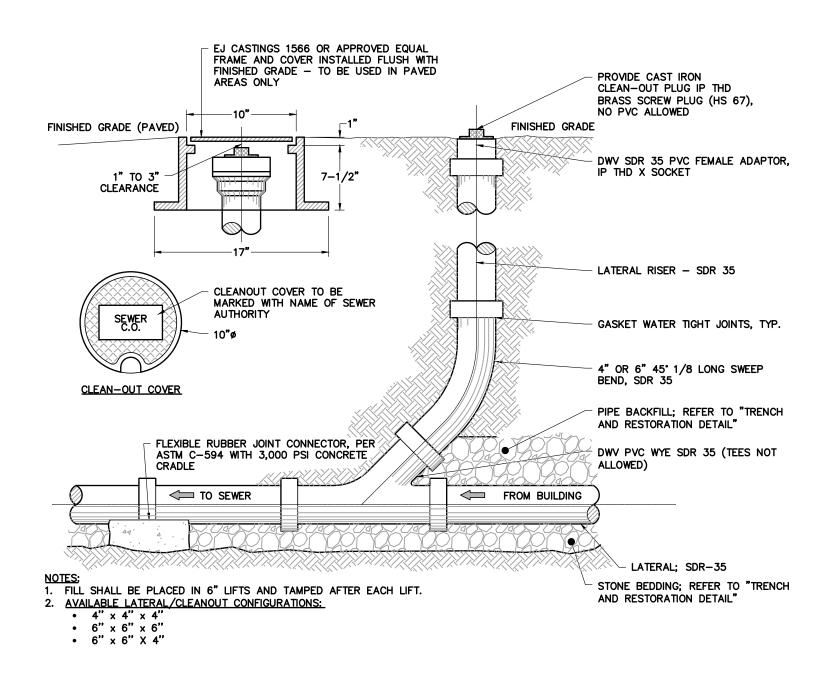

BUILDING AND SEWER CLEAN-OUT
N.T.S.

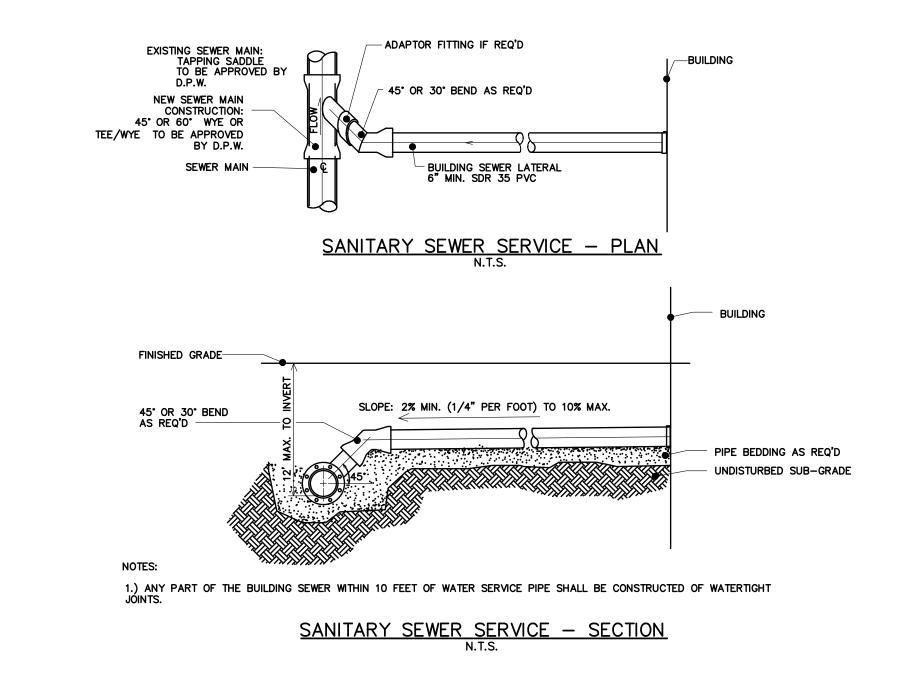

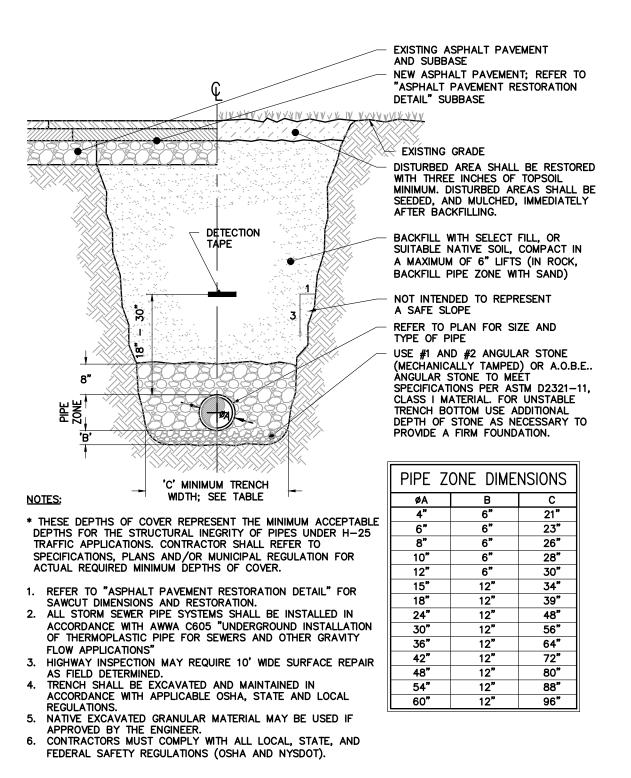

SANITARY SEWER TRENCH & RESTORATION DETAIL N.T.S.

Planning Board-Town of East Greenbush

BY DIRECTION OF CHAIRMAN OF THE PLANNING BOARD THESE PLANS ARE APPROVED. SEE FIRST SHEET FOR DATE & SIGNATURE.


Drawing Copyright © 2019
NOTE: Unauthorized alteration or addition to this map is a violation 2 of the New York State Education law.

Only copies from the original of this map bearing an original signature in red ink, and the embossed seal of the preparer shall be considered to be true and valid copies.

A R T
ENGINEERING

GINEEROAD

Phone: (518) 479-4014
Fax: (518) 477-6371

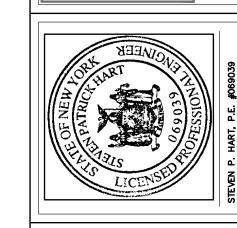

CK,D	SPH	SPH	SPH		
REVD.	DAH	DAH	DAH		
DESCRIPTION	ISSUED FOR REVIEW	ISSUED FOR PRELIMINARY REVIEW	REVISED PER MJ COMMENT LETTER DATED 2/27/23		
DATE	8/3/22	1/5/23	3/21/23		
o O	-	2	ъ		

SANITARY DETAILS
MABEY'S REALTY
STORAGE & COMMERCIAL
BUILDINGS-PHASE 2
486 3RD AVENUE EXTENSION

ENGINEER:

STEVEN P. HART, P.E.

DRAWN BY:

DAH


DATE ISSUED:


AUGUST 2022


SCALE:

NTS
DRAWING NUMBER:


STORM MANHOLE DETAIL

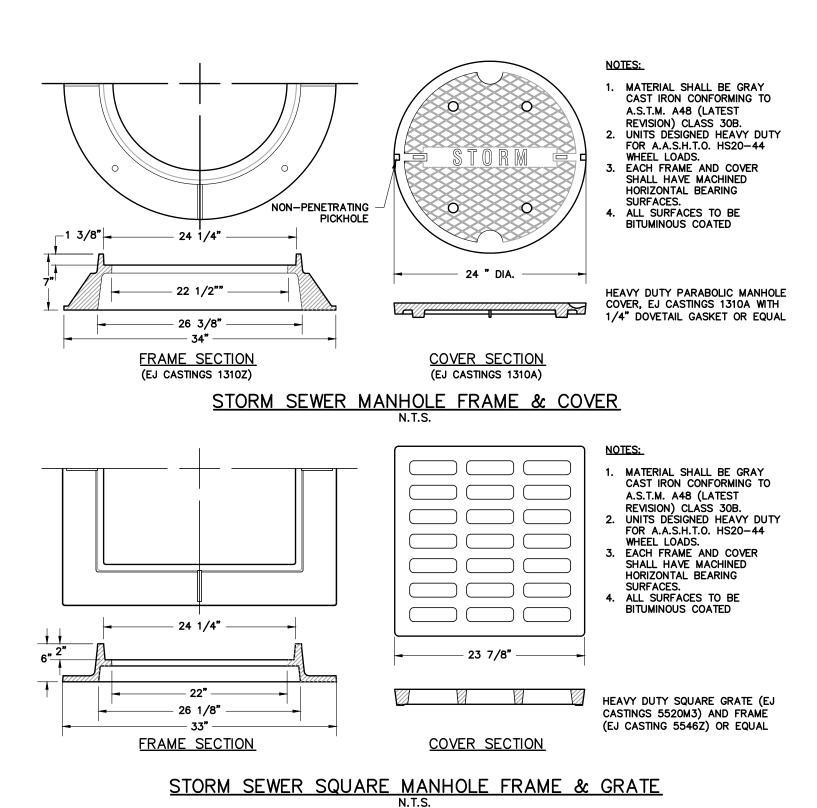

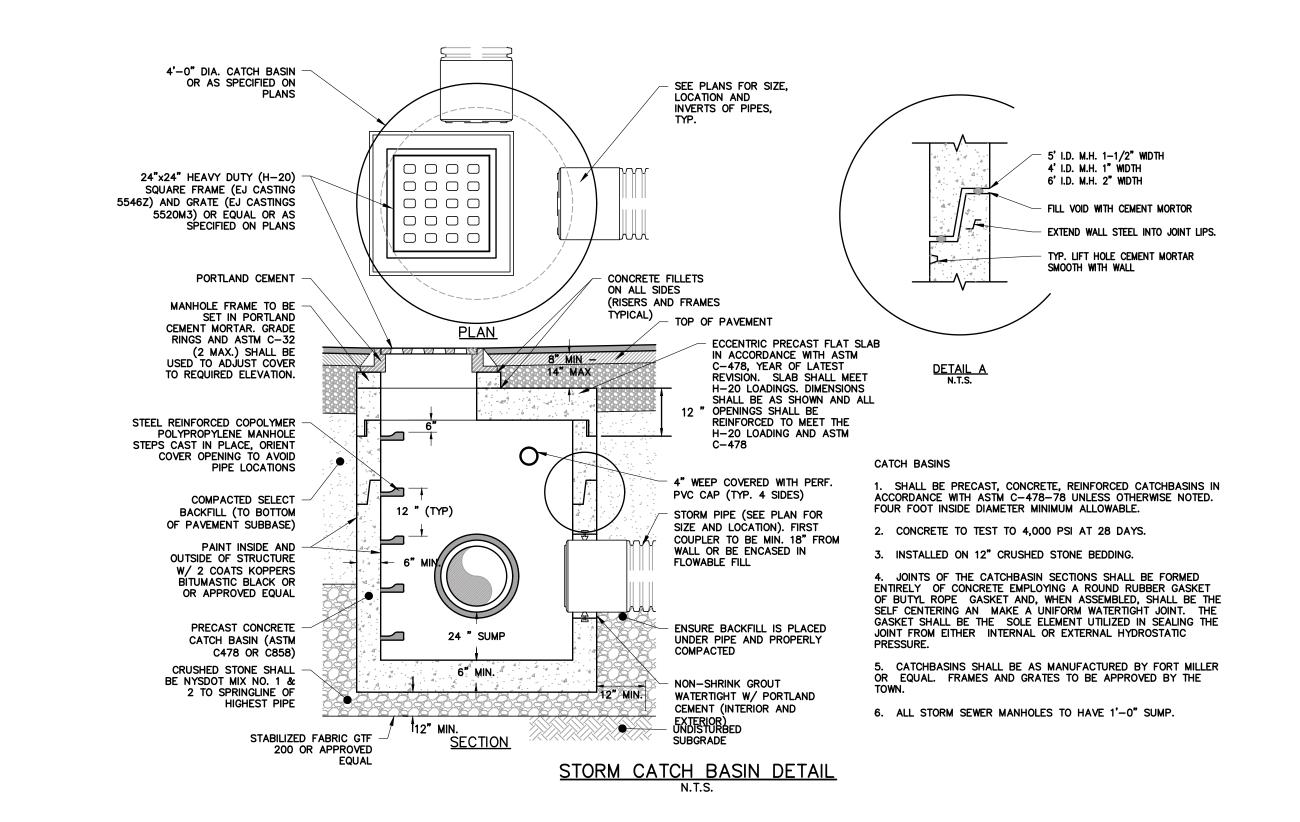

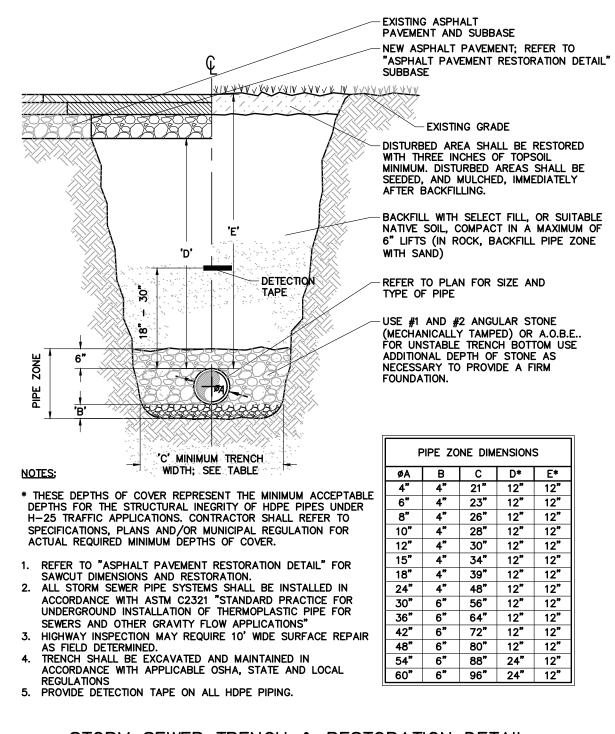




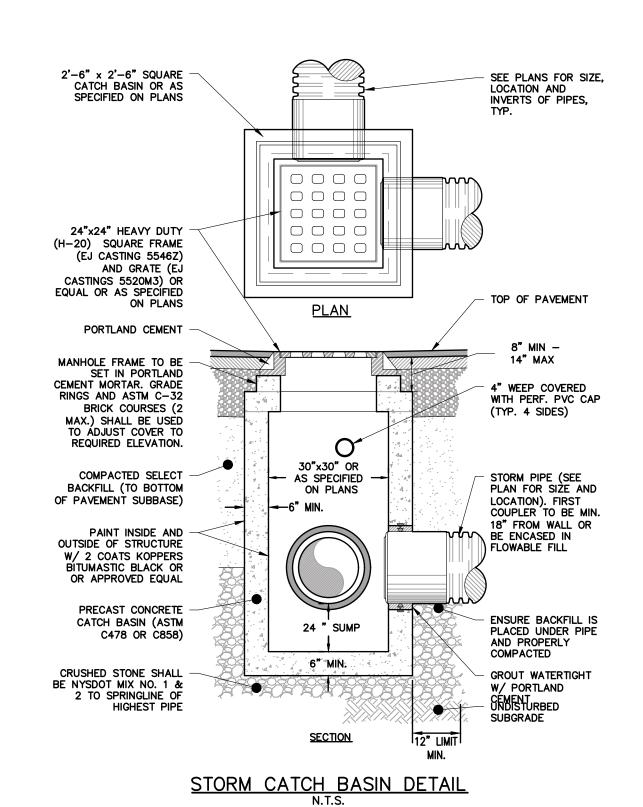

Planning Board-Town of East Greenbush

BY DIRECTION OF CHAIRMAN OF THE PLANNING **BOARD THESE PLANS ARE APPROVED** SEE FIRST SHEET FOR DATE & SIGNATURE Copyright © 201: Unauthorized or addition to violation of secondivision 2 of k State Education.

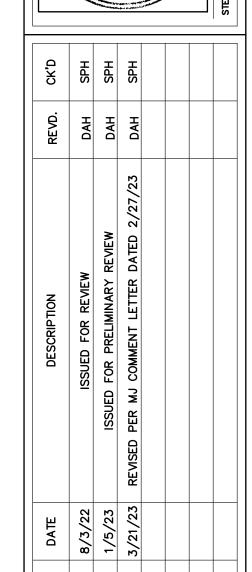


 Ω REALTY COMMER(-PHASE \bigcirc AL | | | | MABEY'S SRAGE & (SUILDINGS-TORM \odot m S

ENGINEER: STEVEN P. HART, P.E. DRAWN BY: DATE ISSUED: SCALE:


DRAWING NUMBER:

- 1. STONE SIZE: USE 2" STONE, OR RECLAIMED OR RECYCLED CONCRETE EQUIVALENT.
- 2. THICKNESS: NOT LESS THAN SIX (6) INCHES.
- 3. WIDTH: TWELVE (12) FOOT MINIMUM, BUT NOT LESS THAN THE FULL WIDTH AT POINTS WHERE INGRESS OR EGRESS OCCURS. TWENTY-FOUR(24) FOOT IF SINGLE ENTRANCE TO SITE.
- 4. LENGTH: AS REQUIRED, BUT NOT LESS THAN 50' (EXCEPT ON A SINGLE RESIDENCE LOT WHERE A 30' MINIMUM LENGTH WOULD APPLY).
- 5. FILTER CLOTH: WILL BE PLACED OVER THE ENTIRE AREA PRIOR TO PLACING OF STONE.
- 6. SURFACE WATER: ALL SURFACE WATER FLOWING OR DIVERTED TOWARD CONSTRUCTION ENTRANCES SHALL BE PIPED ACROSS THE ENTRANCE. IF PIPING IS IMPRACTICAL, A MOUNTABLE BERM WITH 5:1 SLOPES WILL BE PERMITTED.
- 7. MAINTENANCE: THE ENTRANCE SHALL BE MAINTAINED IN A CONDITION WHICH WILL PREVENT TRACKING OR FLOWING OF SEDIMENT ONTO PUBLIC RIGHTS-OF-WAY. THIS MAY REQUIRE PERIODIC TOP DRESSING WITH ADDITIONAL STONE AS CONDITIONS DEMAND AND REPAIR AND/OR CLEANOUT OF ANY MEASURES USED TO TRAP SEDIMENT. ALL SEDIMENT SPILLED, DROPPED, WASHED OR TRACKED ONTO PUBLIC RIGHTS-OF-WAY MUST BE REMOVED IMMEDIATELY.
- 8. WASHING: WHEELS SHALL BE CLEANED TO REMOVE SEDIMENT PRIOR TO ENTRANCE ONTO PUBLIC RIGHTS-OF-WAY. WHEN WASHING IS REQUIRED, IT SHALL BE DONE ON AN AREA STABILIZED WITH STONE AND WHICH DRAINS INTO AN APPROVED SEDIMENT TRAPPING DEVICE.
- 9. PERIODIC INSPECTION AND NEEDED MAINTENANCE SHALL BE PROVIDED AFTER EACH RAIN.

STABILIZED CONSTRUCTION ACCESS

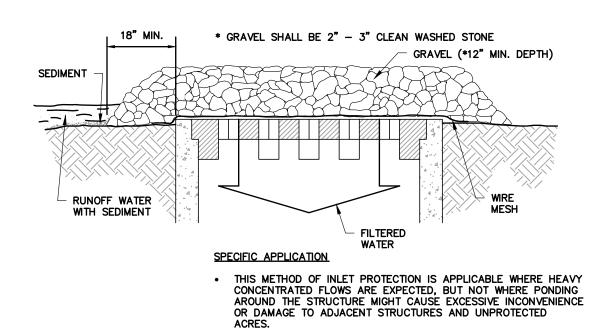

GRAVEL AND WIRE MESH INLET SEDIMENT FILTER

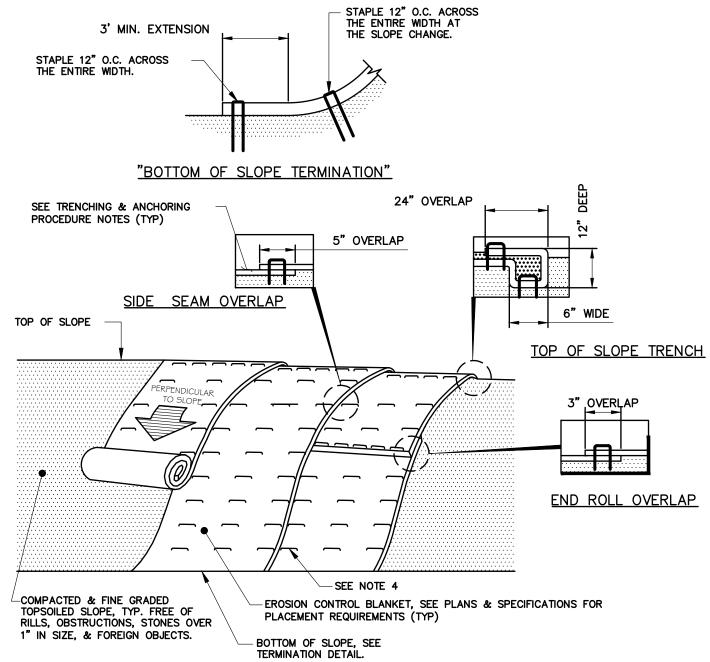

- 1. PREPARE THE TOPSOIL (SEEDBED) FIRST BY RAKING, SHAPING, FINE GRADING, COMPACTING, SEEDING & FERTILIZING THE SLOPES.
- 2. USE THE TRENCHING & ANCHORING PROCEDURES DETAILED HEREIN TO SECURE ANY EXPOSED MATERIAL ENDS. SECURE ALL PRODUCT OVERLAPS. OVERLAP IN THE DIRECTION OF WATER FLOW, PERPENDICULAR TO THE SLOPE.
- 3. KEEP EROSION CONTROL BLANKET IN SOLID CONTACT WITH THE TOPSOIL.
- 4. USE THE REQUIRED NUMBER OF STAPLES/STAKES TO SECURELY FASTEN THE EROSION CONTROL BLANKET TO THE SLOPE. IN LOOSE SOIL CONDITIONS, THE USE OF STAPLES/STAKES LENGTHS GREATER THAN 6" MAYBE NECESSARY FOR PROPER SECURING. STAPLE PATTERNS & OVERLAPS ARE DEPENDENT ON SITE CONDITIONS & MANUFACTURER'S REQUIREMENTS. CONTRACTOR SHALL CONSULT WITH MANUFACTURER FOR ACTUAL SITE SPECIFIC REQUIREMENTS.


TRENCHING & ANCHORING PROCEDURE NOTES:

SIDE SEAM OVERLAP: THE EDGES OF PARALLEL BLANKETS SHALL BE STAPLED WITH A 5" OVERLAP. TOP OF SLOPE TRENCH: BEGIN AT THE TOP OF SLOPE BY ANCHORING THE EROSION CONTROL BLANKET IN A 6"D x 6"W TRENCH WITH A 12" OVERLAP EXTENDED BEYOND THE UP-SLOPE PORTION OF THE TRENCH. ANCHOR WITH A ROW OF STAPLES/STAKES 12" O.C. IN THE BOTTOM OF THE TRENCH.


BACKFILL & COMPACT THE TRENCH AFTER STAPLING. APPLY SEED TO THE COMPACTED SOIL & FOLD THE REMAINING 12" PORTION OF THE EROSION CONTROL BLANKET BACK OVER THE SEED & COMPACTED SOIL. SECURE THE EROSION CONTROL BLANKET OVER THE COMPACTED SOIL WITH A ROW OF STAPLES/STAKES SPACED 12" O.C. ACROSS THE ENTIRE WIDTH.

END ROLL OVERLAP: CONSECUTIVE BLANKETS SPLICED DOWN THE SLOPE SHALL BE PLACED END OVER END (SHINGLE-STYLE) WITH A 3" OVERLAP. STAPLE THRU OVERLAPPED AREAS, 12" APART ACROSS THE ENTIRE WIDTH.

EROSION CONTROL BLANKET INSTALLATION
DETAIL
N.T.S.

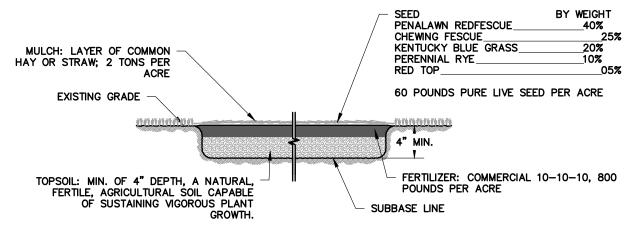


TOPSOIL, FERTILIZER, SEED & MULCH N.T.S.

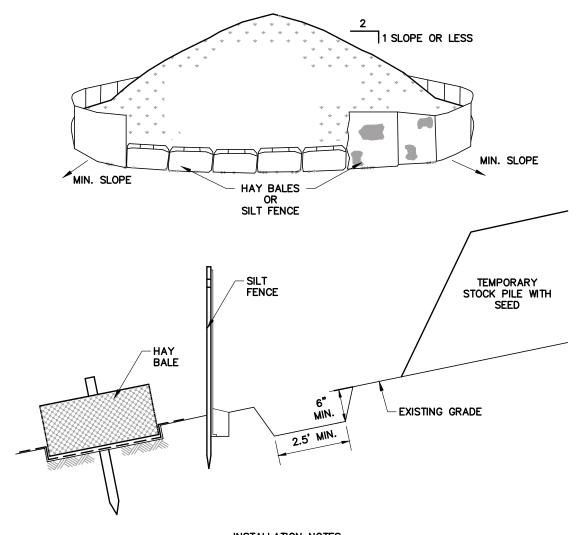


INSTALLATION NOTES: 1. AREA CHOSEN FOR STOCKPILING OPERATIONS SHALL BE DRY AND STABLE.

- 2. MAXIMUM SLOPE OF STOCKPILE SHALL BE 1 : 2.
- 3. UPON COMPLETION OF SOIL STOCKPILING, EACH PILE SHALL BE SURROUNDED WITH EITHER SILT FENCING OR HAY BALES, THEN STABILIZED WITH VEGETATION OR COVERED.
- 4. SEE SPECIFICATIONS FOR INSTALLATION OF SILT FENCE AND HAY BALES.
- 5. THIS DETAIL MAY ALSO BE USED FOR STOCKPILING OF LAND CLEARING DEBRIS, I.E. LOGS/STUMPS AND MULCH

STOCK PILE DETAIL
N.T.S.

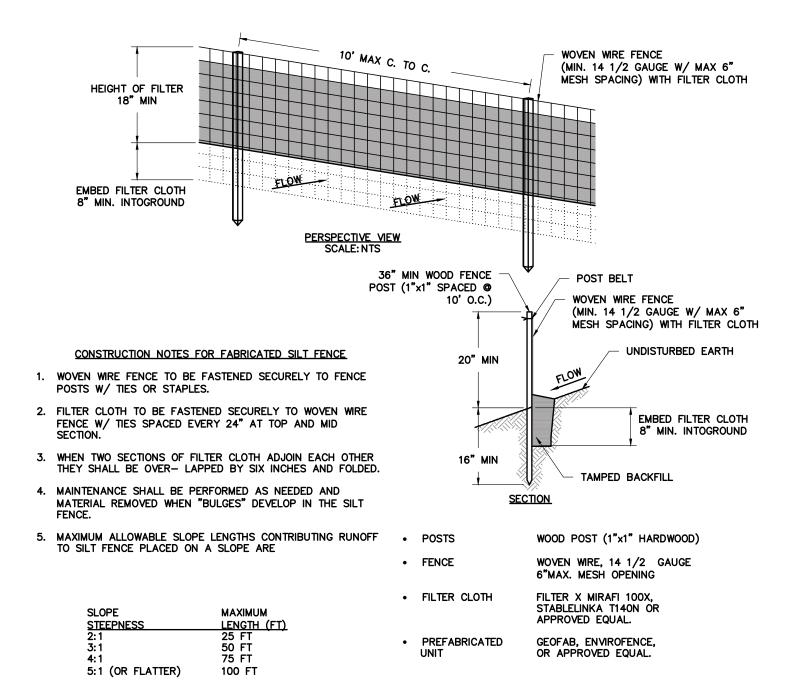


SILT FENCE DETAIL N.T.S.

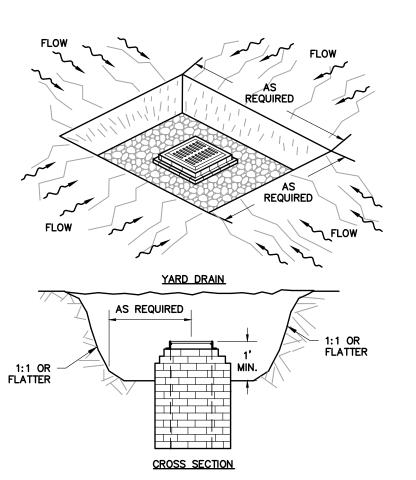

CONSTRUCTION SPECIFICATIONS

- 1. SEDIMENT SHALL BE REMOVED AND THE TRAP RESTORED TO ITS ORIGINAL DIMENSIONS WHEN THE SEDIMENT HAS ACCUMULATED TO 1/2 THE DESIGN DEPTH OF THE TRAP. REMOVED SEDIMENT SHALL BE DEPOSITED IN A SUITABLE AREA AND IN SUCH A MANNER THAT IT WILL NOT ERODE.
- 2. THE VOLUME OF SEDIMENT STORAGE SHALL BE 1800 CUBIC FEET PER ACRE OF CONTRIBUTORY
- 3. THE STRUCTURE SHALL BE INSPECTED AFTER EACH RAIN AND REPAIRS MADE AS NEEDED.
- 4. CONSTRUCTION OPERATIONS SHALL BE CARRIED OUT IN SUCH A MANNER THAT EROSION AND WATER POLLUTION SHALL BE MINIMIZED.
- 5. THE SEDIMENT TRAP SHALL BE REMOVED AND THE AREA STABILIZED WHEN THE CONSTRUCTED DRAINAGE AREA HAS BEEN PROPERLY STABILIZED.
- 6. ALL CUT SLOPES SHALL BE 1:1 OR MAXIMUM DRAINAGE AREA: 3 ACRES FLATTER.

CATCH BASIN SEDIMENT TRAP DETAIL
N.T.S.

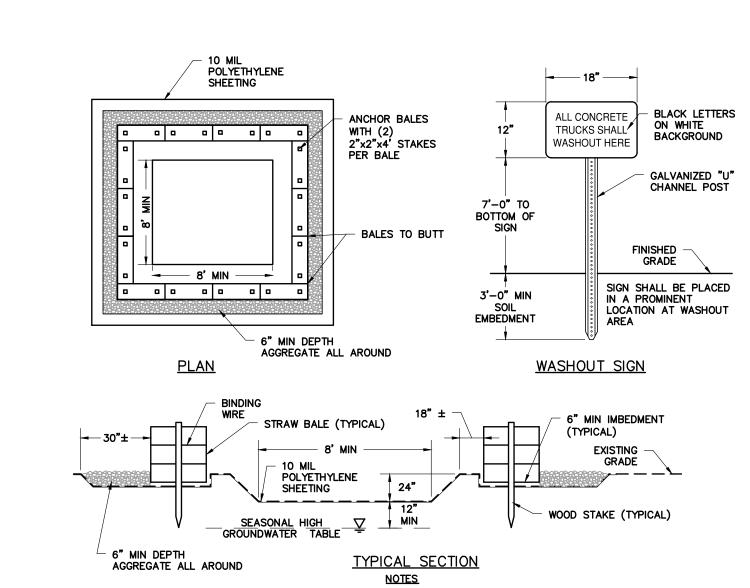


1. CONTAINMENT MUST BE STRUCTURALLY SOUND AND LEAK FREE AND CONTAIN ALL LIQUID WASTES.

- 2. CONTAINMENT DEVICES MUST BE OF SUFFICIENT QUANTITY OR VOLUME TO COMPLETELY CONTAIN THE LIQUID WASTES GENERATED.
- 3. WASHOUT MUST BE CLEANED OR NEW FACILITIES CONSTRUCTED AND READY TO USE ONCE WASHOUT IS 75% FULL
- 4. WASHOUT AREA(S) SHALL BE INSTALLED IN A LOCATION EASILY ACCESSIBLE BY CONCRETE TRUCKS. 5. ONE OR MORE AREAS MAY BE INSTALLED ON THE CONSTRUCTION SITE AND MAY BE RELOCATED AS CONSTRUCTION PROGRESSES.
- 6. AT LEAST WEEKLY REMOVE ACCUMULATION OF SAND AND AGGREGATE AND DISPOSE OF PROPERLY.

CONCRETE WASHOUT AREA DETAIL
N.T.S.

Planning Board-Town of East Greenbush

BY DIRECTION OF CHAIRMAN OF THE PLANNING **BOARD THESE PLANS ARE APPROVED** SEE FIRST SHEET FOR DATE & SIGNATURE

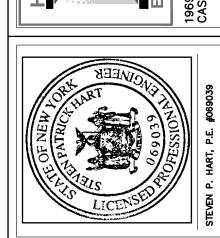

CONTROL AILS Ω ROSION \odot m

ENGINEER: STEVEN P. HART, P.E. DRAWN BY: DATE ISSUED: SCALE:

DRAWING NUMBER: